

### SUMMARY OF DRAINAGE DESIGN

6. SELECT GEOTEXTILE PER AASHTO M 288

PERMEABLE INTERLOCKING CONCRETE

PAVEMENT PATIO WITH AGGREGATE BERMS

- EXISTING DRAINAGE PATTERN FOR LOT IS TO BE RETAINED WITH NO SHEET FLOW DIRECTIONS TO BE CHANGED
- LIMITED ROOF GUTTERING IS CURRENTLY PROPOSED. ROOF DRAINAGE WILL BE CAPTURED IN PIPED FRENCH DRAIN SYSTEM. 3. EXISTING PROPERTY LINE & ADJACENT PROPERTY LANDSCAPE BEDS ARE TO BE RETAINED. THESE BEDS ARE PREVENTING DRAINAGE ON TO ADJACENT RESIDENCES.

### GRADING & DRAINAGE NOTES

AREAS.

PRIOR TO CONSTRUCTION CONTRACTOR TO VERIFY LOCATION OF ALL EXISTING AND PROPOSED UTILITIES. IF CONFLICTS EXIST WITH PROPOSED WORK CONTACT LANDSCAPE ARCHITECT, OWNER & GENERAL CONTRACTOR IMMEDIATELY, DO NOT PROCEED WITH CONSTRUCTION. 2. PRIOR TO ANY GRADING WORK COORDINATE ON-SITE MEETING WITH LANDSCAPE ARCHITECT, OWNER & GENERAL CONTRACTOR TO REVIEW EXISTING CONDITIONS & PROPOSED WORK. REVIEW PROPOSED GRADING FOR SITE TO INSURE THAT POSITIVE DRAINAGE CAN BE ACHIEVED WITHOUT DRAINING ONTO ADJACENT PROPERTIES OR CONFLICTING WITH ANY TREE SAVE

3. PRIOR TO WORK VERIFY THAT FULL ARB & MUNICIPAL SIGN OFF HAS BEEN GIVEN & PROPER PERMITTING IS IN PLACE.

4. ALL EROSION CONTROL MEASURES INCLUDING SILT FENCE & CONSTRUCTION ENTRANCE DETAILING TO COMPLY & MEET ALL MUNICIPAL STANDARDS. 5. LANDSCAPE BEDS ADJACENT TO FOUNDATION TO BE BERMED 6" IN ALL AREAS POSSIBLE THAT DO NOT AFFECT POSITIVE DRAINAGE OR TREE SAVE AREAS. REVIEW THIS BERMING DURING PRE-CONSTRUCTION MEETING WITH LANDSCAPE ARCHITECT, OWNER & GENERAL CONTRACTOR.

WITHIN TREE SAVE AREAS LIMIT FINE GRADING FILL TO 1" OR LESS ABOVE EXISTING GRADE & NO MACHINE GRADING ALLOWED. REVIEW ANY PROPOSED HAND GRADING WITHIN TREE PROTECTION ZONES WITH LANDSCAPE ARCHITECT PRIOR TO WORK. TO NOT PLACE FILL ON MAIN ROOT ARCH OF TREE. 7. ALL DRIVES & WALKS TO HAVE LESS THAN 5% SLOPE & COMPLY WITH AMERICAN DISABILITIES ACT GUIDELINES. ALL DRIVES & WALKS TO HAVE A MINIMUM OF 1% SLOPE TO

PREVENT PONDING OF WATER. CONTACT LANDSCAPE ARCHITECT IMMEDIATELY IF THESE PARAMETERS CAN NOT BE PROVIDED. DO NOT INSTALL WORK. 8. FOR AREAS REQUIRING GRADING WITH SLOPES 3:1 OR GREATER STABILIZE SLOPE IMMEDIATELY WITH FINAL LANDSCAPING OR TEMPORARY MEASURES TO PREVENT EROSION. CONTRACTOR IS RESPONSIBLE FOR MEETING ALL EROSION CONTROL MEASURES REQUIRED. FOR ANY SLOPES 2:1 OR GREATER INSTALL PINNED JUTE MESH TO RETAIN SLOPE. 9. PRIOR TO ANY WORK VERIFY THIS LOTS FLOOD ELEVATION & MUNICIPAL FLOOD REQUIREMENTS FOR ANY REQUIRED INCREASE IN FINISH FLOOR ELEVATION ABOVE FLOOD ELEVATION REQUIRED BY MUNICIPAL BUILDING CODE (IE+2'). ONCE VERIFIED CONTACT LANDSCAPE ARCHITECT, GENERAL CONTRACTOR & ARCHITECT IMMEDIATELY IF CONFLICTS OCCUR WITH PROPOSED

ARCHITECTURAL DESIGN OF STRUCTURES DESIGNED TO BE ABOVE OR BELOW REQUIRED MUNICIPAL FLOOD ELEVATION. 10. PRIOR TO WORK FORWARD PROPOSED GRADING & LANDSCAPE DRAWINGS TO ARCHITECT FOR REVIEW. COORDINATE PRE-CONSTRUCTION ON-SITE MEETING WITH GENERAL CONTRACTOR, ARCHITECT & LANDSCAPE ARCHITECT TO REVIEW PROPOSED SITE WORK, GRADING, STAIR LANDINGS, GUTTERING SYSTEMS, MECHANICAL LOCATIONS, LANDSCAPING & UTILITY

11. ALL EXISTING CONDITION INFORMATION TAKEN FROM PLATT BY BRITT LAND SURVEYING DATED 6/12/24.

## BEST MANAGEMENT PRACTICES(BMPs) FOR SITE

\*\*\*NOTE THE FOLLOWING IS INTENDED AS THE MINIMUM STORM WATER POLLUTION CONTROL REQUIREMENTS TO BE IMPLEMENTED & FOLLOWED THROUGH THE ENTIRE CONSTRUCTION PROCESS. IS THE GENERAL CONTRACTORS RESPONSIBILITY TO WEEKLY INSPECT ENTIRE PROPERTY TO VERIFY ALL REQUIREMENTS ARE BEING FOLLOWED. RECORD INSPECTION DATE & ANY NOTED DEFICIENCIES & REPARATIVE MEASURES TAKEN IN BMP INSPECTION LOG STORED IN ON-SITE PERMIT BOX. AFTER ANY RAIN EVENT GENERAL CONTRACTOR TO INSPECT SILT FENCE & MAKE ANY REPAIRS NECESSARY. IF MUNICIPAL INSPECTOR, ARCHITECT, LANDSCAPE ARCHITECT OR OWNER DEEMS ADDITIONAL BMP MEASURES ARE REQUIRED DURING CONSTRUCTION, GENERAL CONTRACTOR TO IMPLEMENT AS NEEDED.

1. PRIOR TO ANY WORK INSTALL SILT FENCE, TREE PROTECTION & CONSTRUCTION ENTRANCE MEETING OR EXCEEDING MUNICIPAL REQUIREMENTS. CONTACT MUNICIPALITY FOR ALL REQUIRED INSPECTIONS & APPROVALS OF THESE ITEMS.

2. ANY ERODED SEDIMENTS & OTHER POLLUTANTS MUST BE RETAINED ON SITE & MAY NOT BE TRANSPORTED FROM THE SITE VIA SHEET FLOW, SWALES, AREA DRAINS, NATURAL DRAINAGE COURSES OR WIND. GENERAL CONTRACTOR IS RESPONSIBLE FOR IMMEDIATE REPAIR & REMOVAL OF ANY SEDIMENTS. POLLUTANTS OR TRASH IN THE PUBLIC RIGHT OF WAY & ADJACENT PROPERTIES. THIS INCLUDES DAMAGE TO LAWN WITHIN RIGHT OF WAY FROM FOOT OR VEHICULAR TRAFFIC.

3. STOCKPILES OF EARTH & OTHER CONSTRUCTION RELATED MATERIAL MUST BE PROTECTED FROM BEING TRANSPORTED FROM THE SITE BY FORCES OF WIND OR WATER. ANY STOCKPILES OF EARTH BEING TEMPORARILY STAGED OUTSIDE OF CONSTRUCTION LAY DOWN AREA NOTED ON THIS PLAN TO BE REMOVED & REPAIRED IMMEDIATELY. 4. FUELS, OILS, SOLVENTS & OTHER TOXIC MATERIALS MUST BE STORED IN ACCORDANCE WITH THEIR LISTING & ARE NOT TO CONTAMINATE THE SOIL & SURFACE WATERS. ALL APPROVED

STORAGE CONTAINERS ARE TO BE PROTECTED FROM THE WEATHER. SPILLS MUST BE CLEANED UP IMMEDIATELY & DISPOSED OF IN A PROPER MANNER. SPILLS MAY NOT BE WASHED INTO THE LANDSCAPE OR INTO THE DRAINAGE SYSTEM. 5. NON-STORMWATER RUNOFF FROM EQUIPMENT & VEHICLE WASHING & ANY OTHER ACTIVITY SHALL BE CONTAINED AT THE PROJECT SITE.


6. EXCESS OR WASTE CONCRETE MAY NOT BE WASHED INTO THE PUBLIC RIGHT OF WAY OR ANY DRAINAGE SYSTEM. PROVISIONS SHALL BE MADE TO RETAIN CONCRETE WASTES ON SITE UNTIL TRASH & CONSTRUCTION RELATED SOLID WASTES MUST BE DEPOSITED INTO A COVERED RECEPTACLE TO PREVENT CONTAMINATION OF RAINWATER & DISPERSAL BY WIND.

8. SEDIMENTS & OTHER MATERIALS MAY NOT BE TRACKED FROM THE SITE BY VEHICULAR OR FOOT TRAFFIC. THE CONSTRUCTION ENTRANCE ROADWAYS MUST BE STABILIZED SO AS TO INHIBIT SEDIMENTS FROM BEING DEPOSITED INTO THE PUBLIC RIGHT OF WAY. ACCIDENTAL DEPOSITIONS MUST BE SWEPT UP IMMEDIATELY & MAY NOT BE WASHED DOWN BY RAIN OR OTHER MEANS. 9. ANY SLOPES WITH DISTURBED SOILS OR DENUDED OF VEGETATION MUST BE STABILIZED SO AS TO INHIBIT EROSION BY WIND & WATER. 10. IF TROPICAL FORCE WINDS OR GREATER ARE PREDICTED TO IMPACT SITE GENERAL CONTRACTOR IS RESPONSIBLE TO BEGIN SECURING THE SITE 24 HOURS PRIOR TO EVENT. GENERAL

CONTRACTOR IS RESPONSIBLE FOR REMOVING OR SECURING ANY & ALL ITEMS THAT CAN ACT AS PROJECTILES OR BECOME AIRBORNE AS TRASH & DEBRIS.

\*\*\* AS THE PROJECT GENERAL CONTRACTOR, I HAVE READ & UNDERSTAND THE REQUIREMENTS LISTED ABOVE, NECESSARY TO CONTROL STORM WATER POLLUTION FROM SEDIMENTS, EROSION & CONSTRUCTION MATERIALS & I CERTIFY THAT I WILL COMPLY WITH THESE REQUIREMENTS.

PRINT NAME (GENERAL CONTRACTOR) SIGNATURE (GENERAL CONTRACTOR)

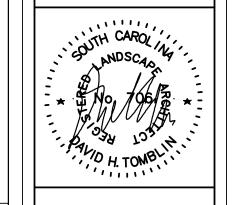

TOMBLIN COMPANY, LL

LANDSCAPE

**ARCHITECTURE** 

LAND PLANNING

HISTORIC

RENOVATION

AMERICAN SOCIETY

716 FORT SUMTER DRIVE

CHARLESTON


SOUTH CAROLINA

1.843.412.2894


FAX 1.843.406.2721

tomblincompany.com

OF LANDSCAPE ARCHITECT

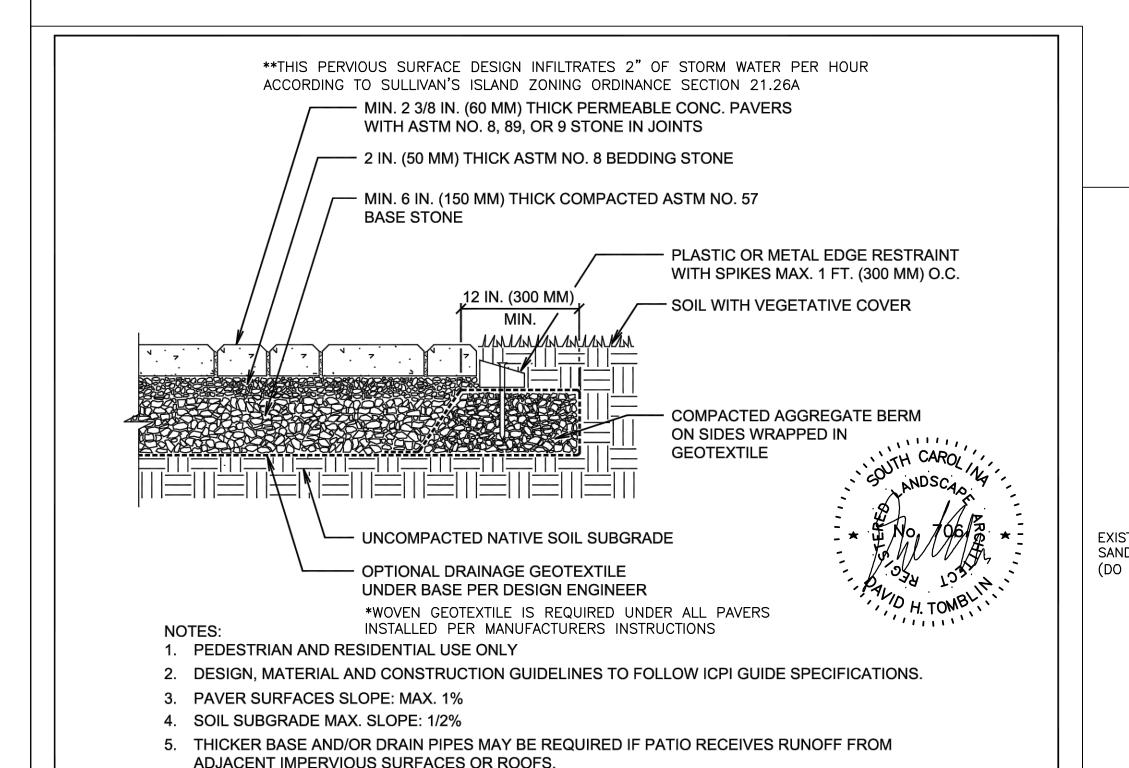

### PERVIOUS PATH DETAIL (VIEW FACES FRONT OF PROPERTY) 3/4"=1'-0" - SLATE CHIPS, 3" DEEP OVER PINNED

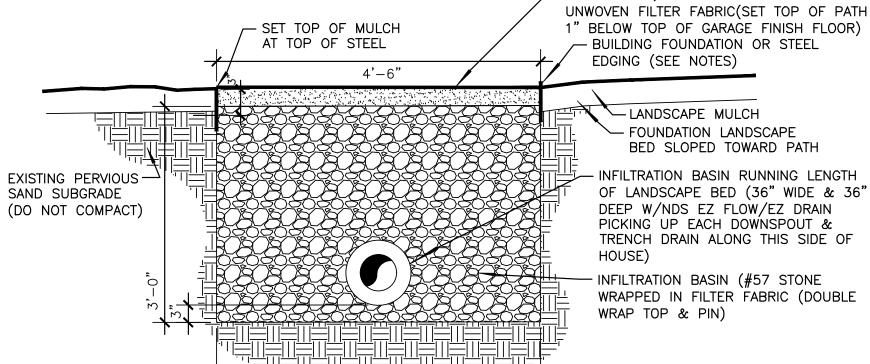

1) STEEL EDGING TO BE BORDER CONCEPTS-BORDER KING STEEL EDGING(BLACK) OR EQUAL. INSTALL AS PER MANUFACTURERS INSTRUCTIONS UTILIZING 16' CONTINUOUS RUNS WHEREVER POSSIBLE.

2) PRIOR TO WORK REVIEW EXISTING CONDITIONS WITH LANDSCAPE ARCHITECT. 3) PROVIDE 3-2" SLEEVES EVENLY ALONG PATH FOR IRRIGATION & LOW VOLTAGE


4) HARD PIPE ALL DOWNSPOUTS WITH SCHEDULE 40 PVC TO EZ FLOW/EZ DRAIN.

# NDS DURA SLOPE TRENCH DRAIN DETAIL

NOT TO SCALE

1) ALL TRENCH DRAIN COMPONENTS TO BE INSTALLED PER MANUFACTURERS INSTRUCTION BY A CONTRACTOR EXPERIENCED IN INSTALLING NDS DURA-SLOPE TRENCH DRAIN. 2) PRIOR TO ANY WORK COORDINATE ON-SITE MEETING WITH LANDSCAPE ARCHITECT, ARCHITECT & GENERAL CONTRACTOR TO REVIEW GRADING PLAN & PROPOSED SWALE LOCATIONS & IN PARTICULAR FOUNDATION FRENCH DRAIN & ROOF GUTTER SYSTEMS TIE INS.

3) LANDSCAPE ARCHITECT AND OWNER RESERVE THE RIGHT TO REJECT CONSTRUCTION DUE TO POOR WORKMANSHIP.

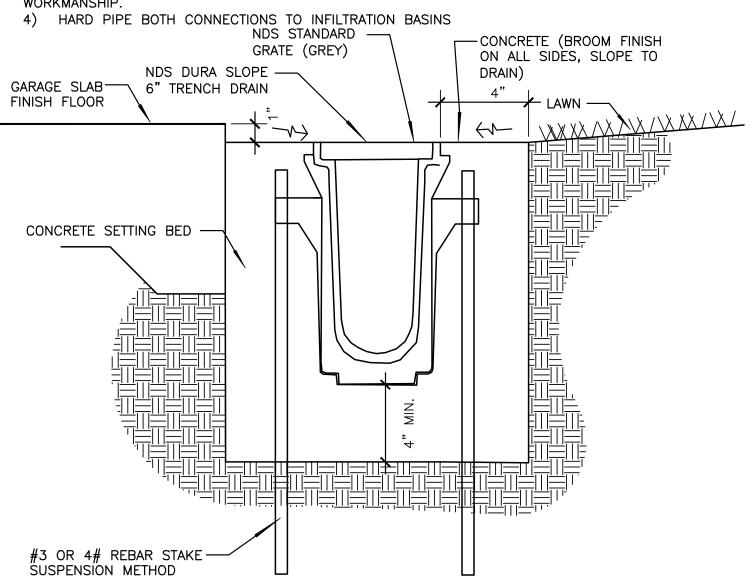

ARCHITE( FOR ANDSCAP

SERV

JOB NUMBER 025075

DHT drawn		DHT CHECK				
REVISED						

SHEET TITLE

STORMWATER PLAN DETAILS &

SHEET NUMBER

LANDSCAPE DRAINAGE SWALE DETAIL (THIS VIEW FACES FRONT OF PROPERTY) 3/4"=1'-0" BUILDING WALL (SEE \ARCHITECTURE) - LANDSCAPE PLANTINGS LANDSCAPE PLANTINGS --SIDE SLOPES TO BE MAXIMUM 3:1 & -(SEE PLANTING PLAN) (SEE PLANTING PLAN) MINIMUM 5:1 TO CONTAIN FLOW & PREVENT EROSION ISSUES (INSTALL 10' WIDE STRIP OF JUTE MESH UNDER FINAL LANDSCAPE MULCH. 2' ON BOTH SIDES OF SWALE & PIN) -JUTE MESH WITH LANDSCAPE MULCH I) PRIOR TO ANY WORK VERIFY LOCATION OF ALL UTILITIES 2) PRIOR TO ANY WORK COORDINATE ON—SITE MEETING WITH LANDSCAPE ARCHITECT, ARCHITECT & EXISTING SUBGRADE - EXISTING PERVIOUS GENERAL CONTRACTOR TO REVIEW GRADING PLAN & PROPOSED SWALE LOCATIONS & IN PARTICULAR (DO NOT COMPACT) SAND SUBGRADE FOUNDATION FRENCH DRAIN & ROOF GUTTER SYSTEMS TIE INS. (DO NOT COMPACT) INFILTRATION SWALE SUB-BASE & 3) LANDSCAPE ARCHITECT AND OWNER RESERVE THE RIGHT TO REJECT CONSTRUCTION DUE TO POOR INFILTRATION BASIN (#57 STONE WORKMANSHIP. WRAPPED IN FILTER FABRIC (DOUBLE 4) HARD PIPE ALL DOWNSPOUTS WITH SCHEDULE 40 PVC TO EZ FLOW/EZ DRAIN. WRAP TOP & PIN) INFILTRATION BASIN RUNNING LENGTH OF LANDSCAPE BED (36" WIDE & 24" DEEP W/NDS EZ FLOW/EZ DRAIN PICKING UP EÁCH DOWNSPOUT & TRENCH DRAIN

ALONG THIS SIDE OF HOUSE)

16'-0"

ICPI-78

NO SCALE

6'-0" SWALE WIDTH


PROPERTY LINE (PRIOR TO ANY WORK VERIFY THAT ALL PROPOSED

GRADES CAN BE ACHIEVED WITH OUT GRADING ON ADJACENT PROPERTY OR TRAPPING WATER

LENGTH OF HOUSE

ON ADJACENT PROPERTY)

REVIEW SET-NOT FOR CONSTRUCTION

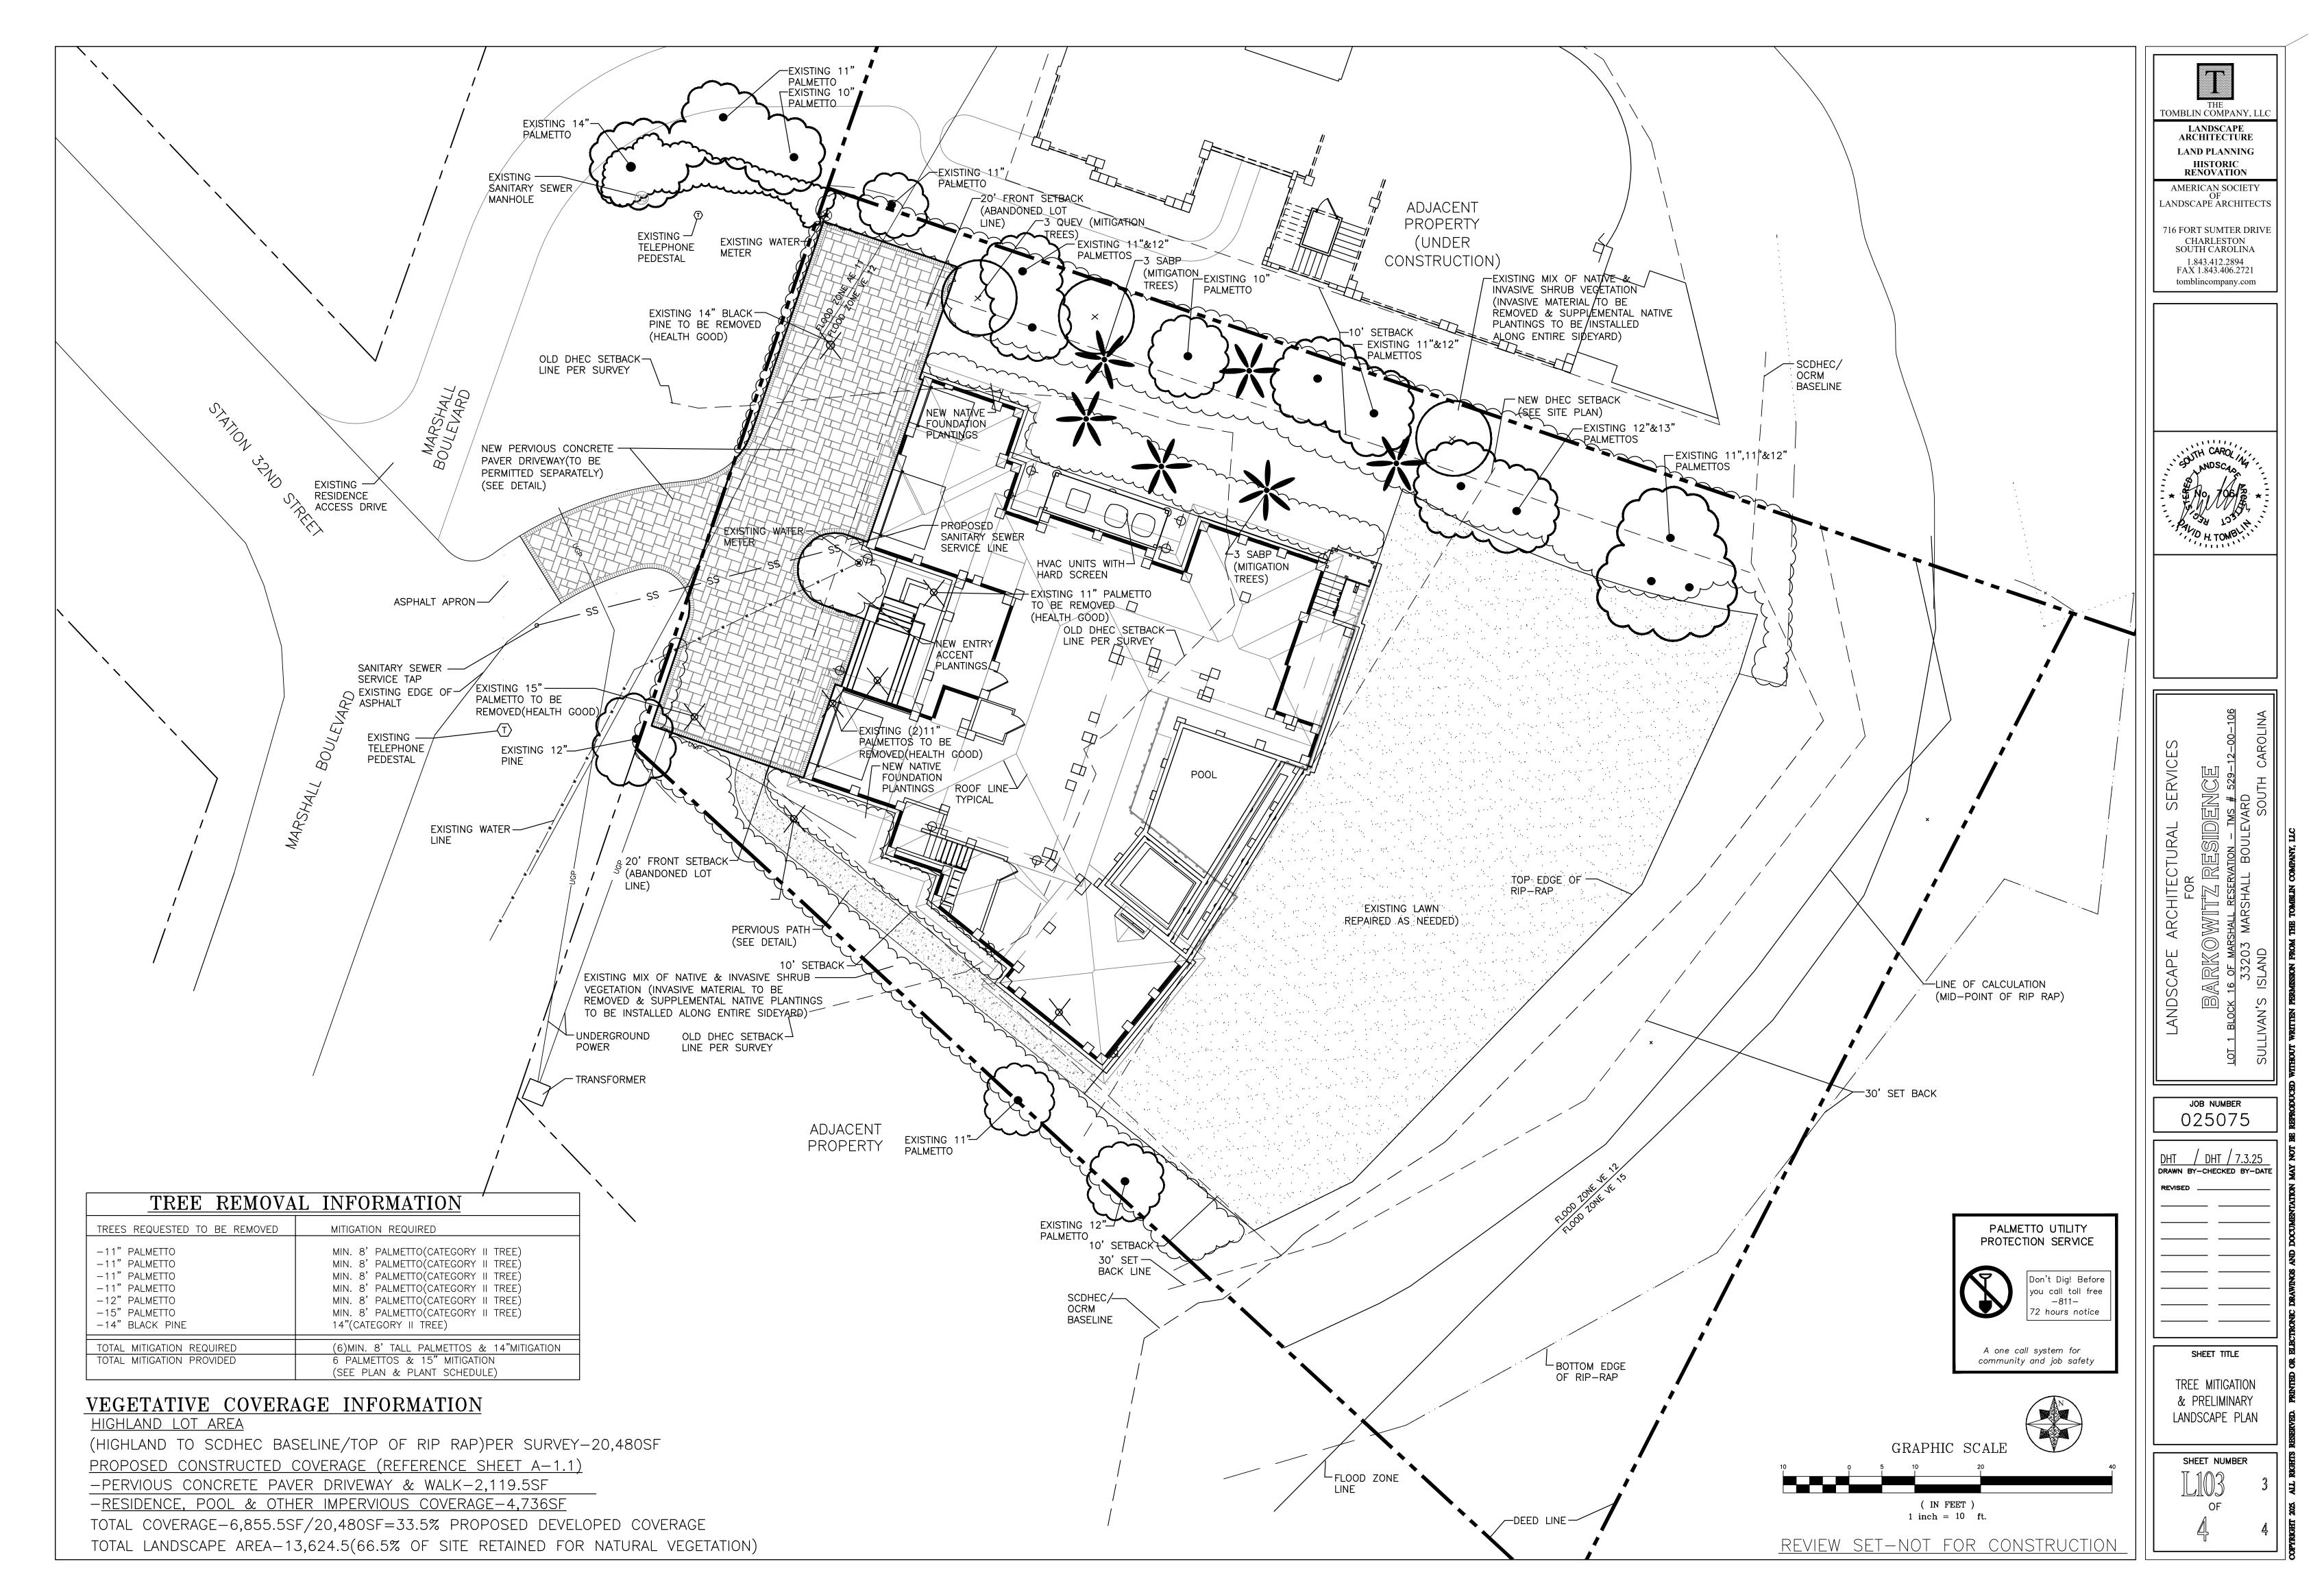

#### LANDSCAPE NOTES:

- 1. PLANT MATERIAL SHALL BE FURNISHED AND INSTALLED AS INDICATED; INCLUDING ALL LABOR, MATERIALS, PLANTS, EQUIPMENT, INCIDENTALS, AND CLEAN-UP.
- 2. THE CONTRACTOR SHALL BE RESPONSIBLE FOR PLANTING AT CORRECT GRADES AND ALIGNMENT, LAYOUT TO BE APPROVED BY OWNERS REPRESENTATIVE PRIOR TO INSTALLATION.
- 3. PLANTS SHALL BE TYPICAL OF THEIR SPECIES AND VARIETY; HAVE NORMAL GROWTH HABITS; WELL DEVELOPED BRANCHES, DENSELY FOLIATED, VIGOROUS ROOT SYSTEMS AND BE FREE FROM DEFECTS AND INJURIES.
- 4. CONTRACTOR SHALL REPORT ANY SOIL OR DRAINAGE CONDITIONS CONSIDERED DETRIMENTAL TO THE GROWTH OF PLANT MATERIAL.
- 5. ALL PLANT MATERIAL SHALL BE GUARANTEED BY THE CONTRACTOR TO BE IN VIGOROUS GROWING CONDITION. PROVISION SHALL BE MADE FOR A GROWTH GUARANTEE OF AT LEAST ONE YEAR FROM THE DATE OF ACCEPTANCE FOR TREES AND SHRUBS. REPLACEMENTS SHALL BE MADE AT THE BEGINNING OF THE FIRST SUCCEEDING PLANTING SEASON. ALL REPLACEMENTS SHALL HAVE A GUARANTEE EQUAL TO THAT STATED ABOVE.
- 6. INSOFAR AS IT IS PRACTICABLE, PLANT MATERIAL SHALL BE PLANTED ON THE DAY OF DELIVERY. IN THE EVENT THIS IS NOT POSSIBLE, THE CONTRACTOR SHALL PROTECT STOCK NOT PLANTED. PLANTS SHALL NOT REMAIN UNPLANTED FOR LONGER THAN A THREE DAY PERIOD AFTER DELIVERY. ANY PLANTS NOT INSTALLED DURING THIS PERIOD WILL BE REJECTED.
- 7. QUALITY AND SIZE OF PLANTS, SPREAD OF ROOTS, AND SIZE OF BALLS SHALL BE IN ACCORDANCE WITH ANSI Z60.1 "AMERICAN STANDARD FOR NURSERY STOCK" AS PUBLISHED BY THE AMERICAN HORT.
- 8. ALL PLANTS SHALL BE PLANTED IN AMENDED TOP SOIL THAT IS THOROUGHLY WATERED AND TAMPED AS BACK FILLING PROGRESSES. PLANTING MIX TO BE AS SHOWN ON PLANTING DETAILS WITH 4" OF CLEAN COMPOST TILLED IN ALL PLANTING AREAS. CONTACT LANDSCAPE ARCHITECT FOR SOIL
- TEST AND FERTILIZER AS SPECIFIED, SUBMIT PURCHASE ORDERS TO LANDSCAPE ARCHITECT. 9. PLANTS SHALL NOT BE BOUND WITH WIRE OR ROPE AT ANY TIME SO AS TO DAMAGE THE BARK OR BREAK BRANCHES. PLANTS SHALL BE HANDLED FROM THE BOTTOM OF THE BALL ONLY.
- 10. PLANTING OPERATIONS SHALL BE PERFORMED DURING PERIODS WITHIN THE PLANTING SEASON WHEN WEATHER AND SOIL CONDITIONS ARE SUITABLE AND IN ACCORDANCE WITH ACCEPTED LOCAL PRACTICE. PLANTS SHALL NOT BE INSTALLED IN TOPSOIL THAT IS IN A MUDDY OR FROZEN CONDITION. DURING SUMMER CONDITIONS ALL PLANT MATERIAL SHALL BE SPRAYED WITH 'WILT-PRUF' OR EQUAL AS PER MANUFACTURER'S INSTRUCTIONS.
- 11. NO PLANT, EXCEPT GROUND COVERS, SHALL BE PLANTED LESS THAN TWO FEET FROM EXISTING STRUCTURES AND SIDEWALKS. PRUNE ALL MATERIAL OUT OF SIDEWALKS, DRIVES AND VISION TRIANGLES.
- 12. SET ALL PLANTS PLUMB AND STRAIGHT. SET AT SUCH LEVEL THAT, A NORMAL OR NATURAL RELATIONSHIP TO THE CROWN OF THE PLANT WITH THE GROUND SURFACE WILL BE ESTABLISHED. LOCATE PLANT IN THE CENTER OF THE PIT.
- 13. ALL INJURED ROOTS SHALL BE PRUNED TO MAKE CLEAN ENDS BEFORE PLANTING UTILIZING CLEAN, SHARP TOOLS. IT IS ADVISABLE TO PRUNE APPROXIMATELY 1/3 OF THE GROWTH OF LARGE TREES (2" CALIPER AND OVER) BY THE REMOVAL OF SUPERFLUOUS BRANCHES, THOSE WHICH CROSS, THOSE WHICH RUN PARALLEL, ETC. MAIN LEADER OF TREES WILL NOT BE CUT BACK. LONG SIDE BRANCHES, HOWEVER, MUST BE SHORTENED. 14. EACH TREE AND SHRUB SHALL BE PRUNED IN ACCORDANCE WITH STANDARD HORTICULTURAL PRACTICE TO PRESERVE NATURAL CHARACTER OF PLANT. PRUNING SHALL BE DONE WITH CLEAN, SHARP TOOLS.
- 15. TREES SHALL BE SUPPORTED IMMEDIATELY AFTER PLANTING. ALL TREES 4 INCHES AND OVER IN CALIPER SHALL BE GUYED. SMALLER TREES SHALL BE STAKED. GUYING WIRES AND STAKES SHALL BE INSTALLED AS INDICATED. THE LANDSCAPE CONTRACTOR SHALL REMOVE STAKING, GUYING &
- TREE WRAP AT THE END OF THE ONE YEAR MAINTENANCE & GUARANTEE PERIOD. 16. THE TRUNKS OF ALL TREES SHALL BE WRAPPED AS SOON AS POSSIBLE AFTER PLANTING ACCORDING TO STANDARD PROCEDURES AND AS
- INDICATED. 17. PRIOR TO ANY LANDSCAPE OR IRRIGATION WORK VERIFY EXISTING CONDITIONS.
- 18. PRIOR TO CONSTRUCTION CONTRACTOR TO VERIFY LOCATION OF ALL EXISTING AND PROPOSED UTILITIES. IF CONFLICTS EXIST WITH PROPOSED
- LOCATIONS OF PLANT MATERIAL CONTACT LANDSCAPE ARCHITECT IMMEDIATELY, DO NOT PLANT MATERIAL.T MATERIAL.
- 19. ALL VINE MATERIAL, TRASH AND INVASIVE SHRUB SPECIES TO BE REMOVED FROM ALL LANDSCAPE AREAS.
- 20. ALL DIMENSIONS ARE B.O.C.(BACK OF CURB) UNLESS OTHERWISE SPECIFIED.

PLANT SHALL BE TRANSPLANTED

AT THE SAME GRADE AS IT BORE

IN THE NURSERY PLOT PRIOR

TO BALLING AND BURLAPPING.

CUT AND REMOVE BURLAP FROM

4"-6" TOPSOIL MOUND

SUBGRADE

TOP ONE-THIRD OF ROOT BALL

AS SHOWN.

- 21. ALL UTILITIES AND OTHER EXISTING CONDITIONS SHOWN ARE IN NO WAY AS-BUILT CONDITIONS. CONTRACTOR MUST VERIFY ALL EXISTING CONDITIONS PRIOR TO CONSTRUCTION. EXISTING UTILITIES AND OTHER EXISTING CONDITIONS MAY VARY GREATLY DUE TO UNDOCUMENTED CONSTRUCTION.
- 22. ALL PLANTING AREAS TO RECEIVE 4" OF PINE STRAW FOR FINAL TOP MULCHING.
- 23. LANDSCAPE CONTRACTOR TO COORDINATE ON-SITE MEETING WITH ARCHITECT, GENERAL CONTRACTOR & LANDSCAPE ARCHITECT TO REVIEW EXISTING CONDITIONS & PROPOSED WORK PRIOR TO ANY IRRIGATION OR LANDSCAPE INSTALLATION.
- 24. SUBMIT IRRIGATION PLAN FOR APPROVAL PRIOR TO ANY WORK. IRRIGATION TO PROVIDE WATER TO ALL NEW PLANTINGS AND LAWN AREAS.
- 25. PRIOR TO ANY WORK VERIFY FULL APPROVAL FROM OWNER & SULLIVANS ISLAND.
- 26. SEE SHEET L101 & L102-STORMWATER PLAN, NOTES & DETAILS FOR ADDITIONAL INFORMATION.

## PRELIMINARY PLANT SCHEDULE

QUA	NTITY/ ABBRY CANOPY TREE	BOTANICAL/COMMON	<u>HEIGHT</u>	SPREAD	CONT	CALIPER	NOTES	TOTAL MITIGATION PROVIDED
<u>3</u>	QUEV	Quercus Virginiana Live Oak	<u>15'min.</u>	<u>5'min.</u>	B&B/Cont.	<u>5" min.</u>	Well Formed	<u>15"</u>
	<u>PALMETTOS</u>	<u> </u>						

<u>Bare Root</u>

<u>\*Full Refoliated Specimen</u>

<u>8' Clear trunk</u>

<u>6-Palmettos</u>

<u>15" & 6-Palmettos</u>

### PLANT SCHEDULE EXPLANATORY NOTES

1.THE FOLLOWING PLANT SCHEDULES ARE PREPARED AS A SELECTION OF PLANTING MATERIALS.

<u>10'min.</u>

2.WHERE AN ABBREVIATION IS SHOWN, FOLLOWING NOTES APPLY: QUAN - QUANTITY OF PLANT MATERIALS REQUIRED FOR PROJECT.

<u>Sabal Palmetto</u>

<u>Cabbage Palm</u>


- (NOTE: CONTRACTOR RESPONSIBLE TO VERIFY QUANTITIES INDICATED.
- ABBRV BOTANICAL ABBREVIATION.

<u>6</u> SABP


- BOTANICAL/COMMON NAME OF PLANT MATERIAL
- HEIGHT HEIGHT OF PLANT MATERIAL SPREAD - DIAMETER OF PLANT MATERIAL
- CONT CONTAINER TYPE WHICH PLANT MATERIAL IS ENCASED UPON SITE DELIVERY.
- (SIZE SHALL TAKE PRECEDENCE OVER CONTAINER.)
- SPACING- DISTANCE FROM CENTER OF EACH PLANT.(PLAN SHALL TAKE PRECEDENCE OVER SCHEDULE.) CAL - CALIPER/DIAMETER OF TRUNK. (REFER TO SPECS FOR MORE SPECIFIC INFORMATION.)
- CALIPER SHALL TAKE PRECEDENCE OVER HEIGHT & SPREAD. NOTES — SPECIFIC NOTES FURTHER SPECIFYING OR DESCRIBING PLANT MATERIAL.
- 3.VERIFY QUANTITIES SHOWN ON PLANT SCHEDULE AND PLANT MATERIAL SHOWN ON PLANTING PLAN.

## TREE PLANTING DETAIL

TREE PLANTING NOTES:

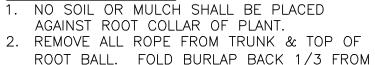

- ROOT BALL 3. PLANTING DEPTH SHALL BE THE SAME OR
- HIGHER AS GROWN IN NURSERY. 4. SET AND MAINTAIN TREE IN (PLUMB)
- VERTICAL POSITION. REMOVE ALL DEAD AND DAMAGED BRANCHES & ALL SUCKER GROWTH. DO NOT CUT CENTRAL LEADER.

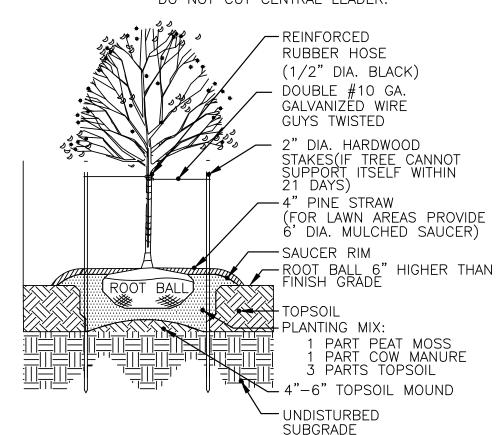



TOMBLIN COMPANY, LLC


LANDSCAPE

**ARCHITECTURE** 

LAND PLANNING

HISTORIC

RENOVATION

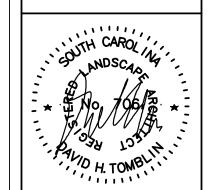

SERVICE ARCHITE( FOR ANDSCAPE

> JOB NUMBER 025075

DHT / DHT / 7.3.25 DRAWN BY-CHECKED BY-DAT

SHEET TITLE


PLANT SCHEDULE LANDSCAPE NOTES & DETAILS

SHEET NUMBER

TIE PALMS FRONDS UP TO PROTECT CROWN, REMOVE 6 WEEKS AFTER PLANTING 2x4 CROSS BRACING EXTEND 2x4s DEEP ENOUGH TO SECURE PALM IN AN UPRIGHT MANNER-KEEP BRACING OUT OF TRAVEL WAYS SET TOP OF ROOTBALL FLUSH W/ FINISHED GRADE. 4" THICK MULCH FOR LAWN AREAS PROVIDE 4' DIA. MULCH RING FINISHED GRADE PLANTING MIXTURE

1. ALL PALMS SHALL BE SPRAY TREATED WITH APPROVED INSECTICIDE AT TIME OF ORIGINAL TRANSPLANTING AND AGAIN AT TIME OF PLANTING. TRUNK OF PALMS SHALL BE NEARLY UNIFORM IN SIZE OVER ENTIRE HEIGHT AND SHALL BE FREE OF DEAD FRONDS, FIRE STUBS, OR OTHER DAMAGE.

- 2. COORDINATE ROOTBALL SIZE WITH PLANTER WIDTHS
- MAINTAIN TREE IN A PLUMB UPRIGHT POSITION.
- ALL CABLE CLAMPS, TURNBUCKLES & BOLTS, TO BE RUST RESIST
- 5. PALMS 30 GAL. OR SMALLER (LESS THAN 8') DO NOT NEED STAKING UNLESS STABILITY BECOMES A PROBLEM. SEE SCHEDULE FOR SIZES.
- 6. LOCATE GUYS WITHIN PLANT BEDS.

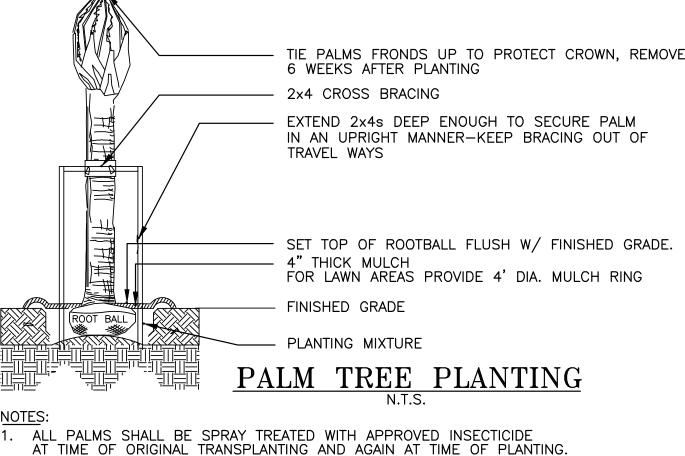

HIGH SIDE OF PLANT BED (IF PLANT BED IS ON A CROSS-SLOPE) SLOPE BED TO DRAIN TO PERIMETER ---4" PINE STRAW PLANT BED TRENCH-EDGING 4" DEPTH FROM GRASS AREA PLANT BED TOPSOIL LAWN -

BUILDING WALL, BED CROWN CENTER LINE OR —

1'-0" TRENCH EDGE DETAIL

7. REMOVE ALL STRAPS AND GUYS AFTER (1) YEAR.

REVIEW SET-NOT FOR CONSTRUCTION

DECIDUOUS AND EVERGREEN SHRUB PLANTING DETAIL

24" MINIMUM

SET TOP OF ROOTBALL

4" PINE STRAW

— FINISHED GRADE

PLANTING MIX:

SAUCER

HIGHER THAN FINISH

(FOR LAWN AREAS PROVIDE

1 PART PEAT MOSS 1 PART COW MANURE

3 PARTS TOPSOIL

FIRM MIXTURE AT 6"-8"

INTERVALS, THOROUGHLY

SETTLE WITH WATER.

5' DIA. MULCHED SAUCER)

INCORPORATE 2" OF PEAT INTO

6" OF PLANTING MIXTURE, AS

(TOP DRESS WITH DOUBLE

SHREDDED HARDWOOD MULCH)

1" FINELY SHREDDED

COMPOSTED BARK

SPECIFIED

'COMPOST/

PLANTING MIX

GROUNDCOVER/ANNUAL PLANTING