

GROUND FLOOR NOTES

ONLY CLASS 4 AND 5 FLOOD RESISTANT MATERIALS SHALL BE INSTALLED BELOW THE DESIGN FLOOD ELEVATION. PER FEMA TECHNICAL BULLETIN 2. 2. NO ELECTRICAL, PLUMBING, MECHANICAL EQUIPMENT OR DUCTWORK WILL BE INSTALLED BELOW DESIGN FLOOD ELEVATION EXCEPT FOR A MAIN SERVICE DISCONNECT, THE TWO CODE REQUIRED EXTERIOR GFCI RECEPTICALS ON THE FRONT AND BACK OF THE STRUCTURE, AND ONE GFCI LIGHT SWITCH. USE 5/8" TYPE X GYPSUM BOARD FOR THE CEIING OF THE GARAGE AND STORAGE AREAS FOR PROPERTY SEPARATION BETWEEN GARAGE SPACE AND HABITABLE SPACE ABOVE.



COPYRIGHT 2024 ALL RIGHTS COPYRIGHT 2024 ALL RIGHTS
RESERVED
IT IS A VIOLATION OF LAW FOR ANY
PERSON, UNLESS ACTING UNDER THE
DIRECTION OF DLB CUSTOM HOME
DESIGN, TO ALTER THIS DOCUMENT.
PRINTED OR ELECTRONIC DRAWINGS
AND DOCUMENTATION MAY NOT BE
REPRODUCED IN ANY FORM WITHOUT
WRITTEN PERMISSION. THIS DRAWING WAS PREPARED AT THE SCALE INDICATED. INACCURACIES IN THE STATED SCALE MAY BE INTRODUCED WHEN DRAWINGS ARE REPRODUCED BY ANY MEANS. USE THE GRAPHIC SCALE BAR TO DETERMINE THE ACTUAL SCALE.

JOB NO.: DESIGN BY:

DRAWN BY:


SCALE: 1/4" = 1'-0" U.N.O.

GROUND FLOOR

SHEET NO.



GROUND FLOOR PLAN
SCALE 3/16" = 1'-0"

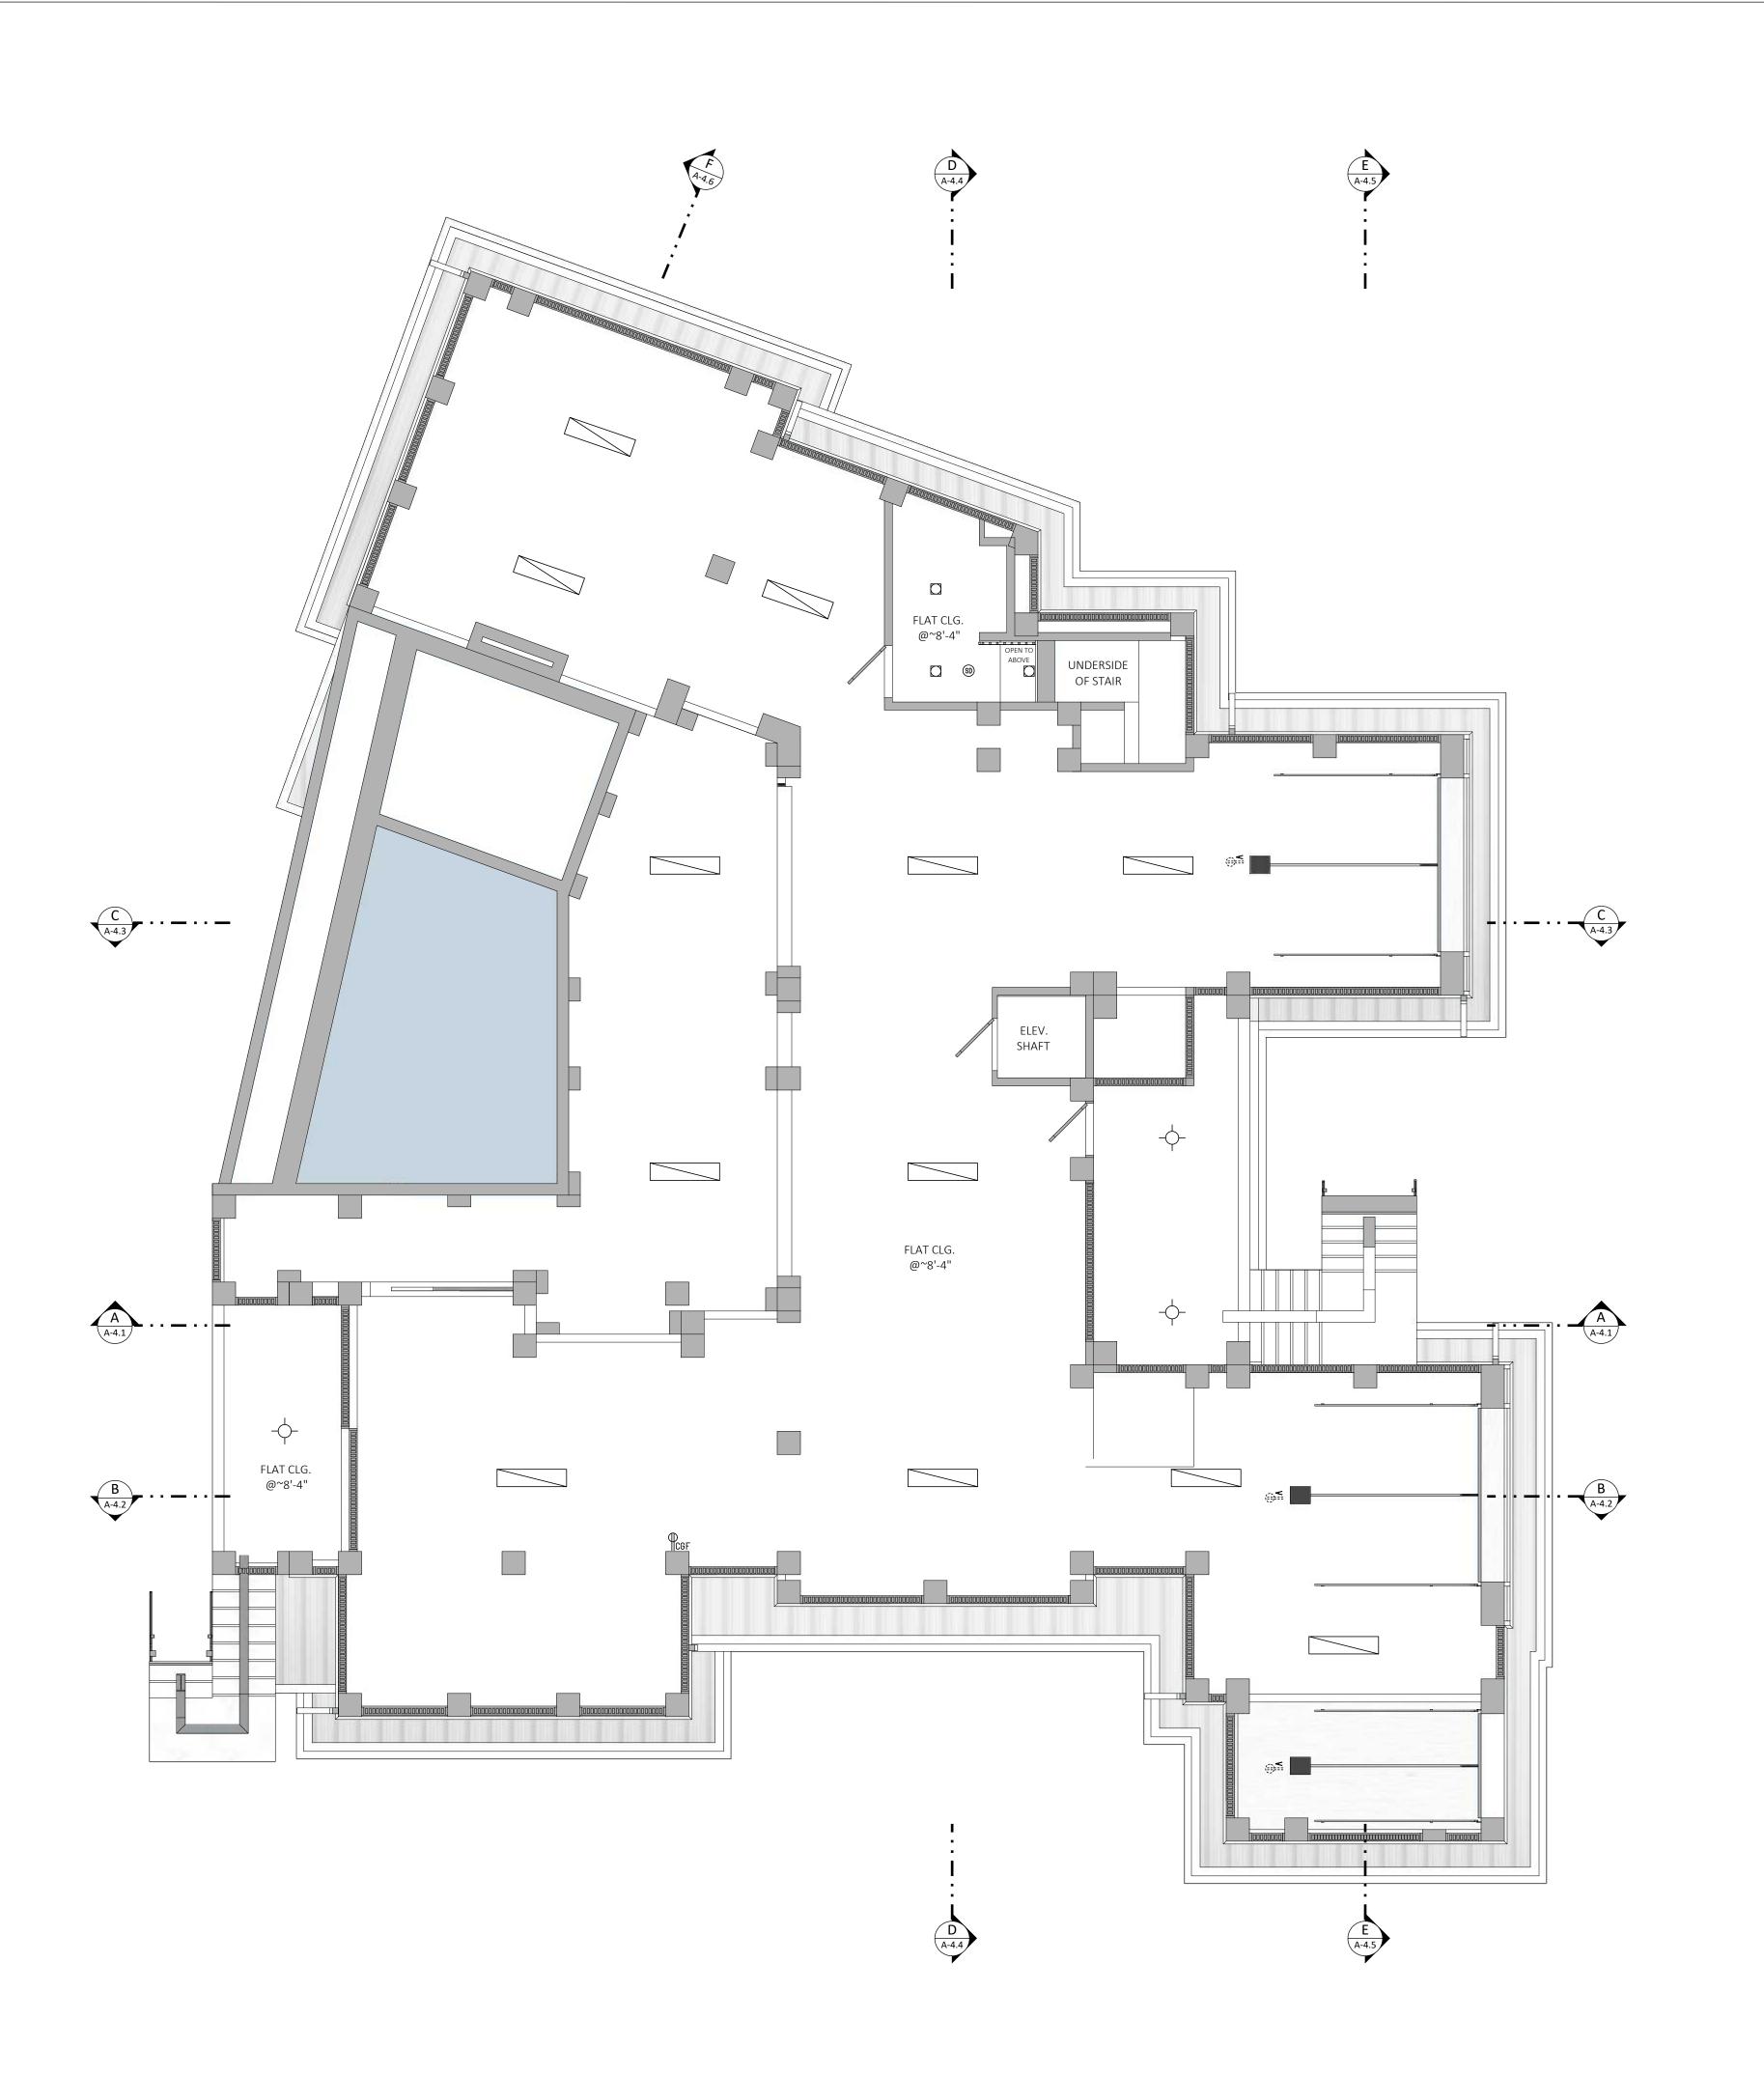

 NO.
 REVISION DESCRIPTION
 DATE

 1
 CONCEPTUAL DESIGN
 07/19/24

 2
 DRB FINAL SUBMITTAL
 01/15/25

 3
 BID SET
 01/29/25

 4
 PERMIT REVIEW SET
 03/20/25

 5
 PERMIT COMMENTS
 06/04/25

 6
 PERMIT COMMENTS
 7/3/2025



SOUTH SOUTH SOUTH SOUTH SOUTH SC Charleston, SC AR.9183

COPYRIGHT 2024 ALL RIGHTS
RESERVED
IT IS A VIOLATION OF LAW FOR ANY
PERSON, UNLESS ACTING UNDER THE
DIRECTION OF DLB CUSTOM HOME
DESIGN, TO ALTER THIS DOCUMENT.
PRINTED OR ELECTRONIC DRAWINGS
AND DOCUMENTATION MAY NOT BE
REPRODUCED IN ANY FORM WITHOUT
WRITTEN PERMISSION.
THIS DRAWING WAS PREPARED AT
THE SCALE INDICATED.
INACCURACIES IN THE STATED
SCALE MAY BE INTRODUCED WHEN
DRAWINGS ARE REPRODUCED BY
ANY MEANS. USE THE GRAPHIC
SCALE BAR TO DETERMINE THE
ACTUAL SCALE.

MAIL: DLBCUSTOMHOMEDESIGN@GMAIL.COM
WWW.DLBCUSTOMHOMEDESIGN.COM

DALY AND SAWYER

CONSTRUCTION CO

855 COLEMAN SC 29464

BARKOWITZ RESIDENCE
ARCHITECTURAL PLANS
3203 MARSHALL BLVD.
SULLIVANS ISLAND
CHARLESTON COUNTY, SC
LOT 1, BLOCK 16,

JOB NO.: 2411

DESIGN BY: DLB

DRAWN BY: DLB

DATE: 6/18/2025


SCALE: 1/4" = 1'-0" U.N.O.

SHEET TITLE:
OUND FLOOR
REFLECTED

CEILING HEIGHTS AND OTHER INFORMATION
SHOWN ON REFLECTED CEILING PLANS ARE NOMINAL
OR APPROXIMATE AND INTENDED TO DEMONSTRATE
DESIGN INTENT AND NOT TAKEN LITERALLY. ALWAYS REFER
TO FLOOR PLANS, ELEVATIONS AND SECTIONS FOR SPECIFIC
PLATE HEIGHTS AND BEARING LOCATIONS.

A2

A-2.0.1

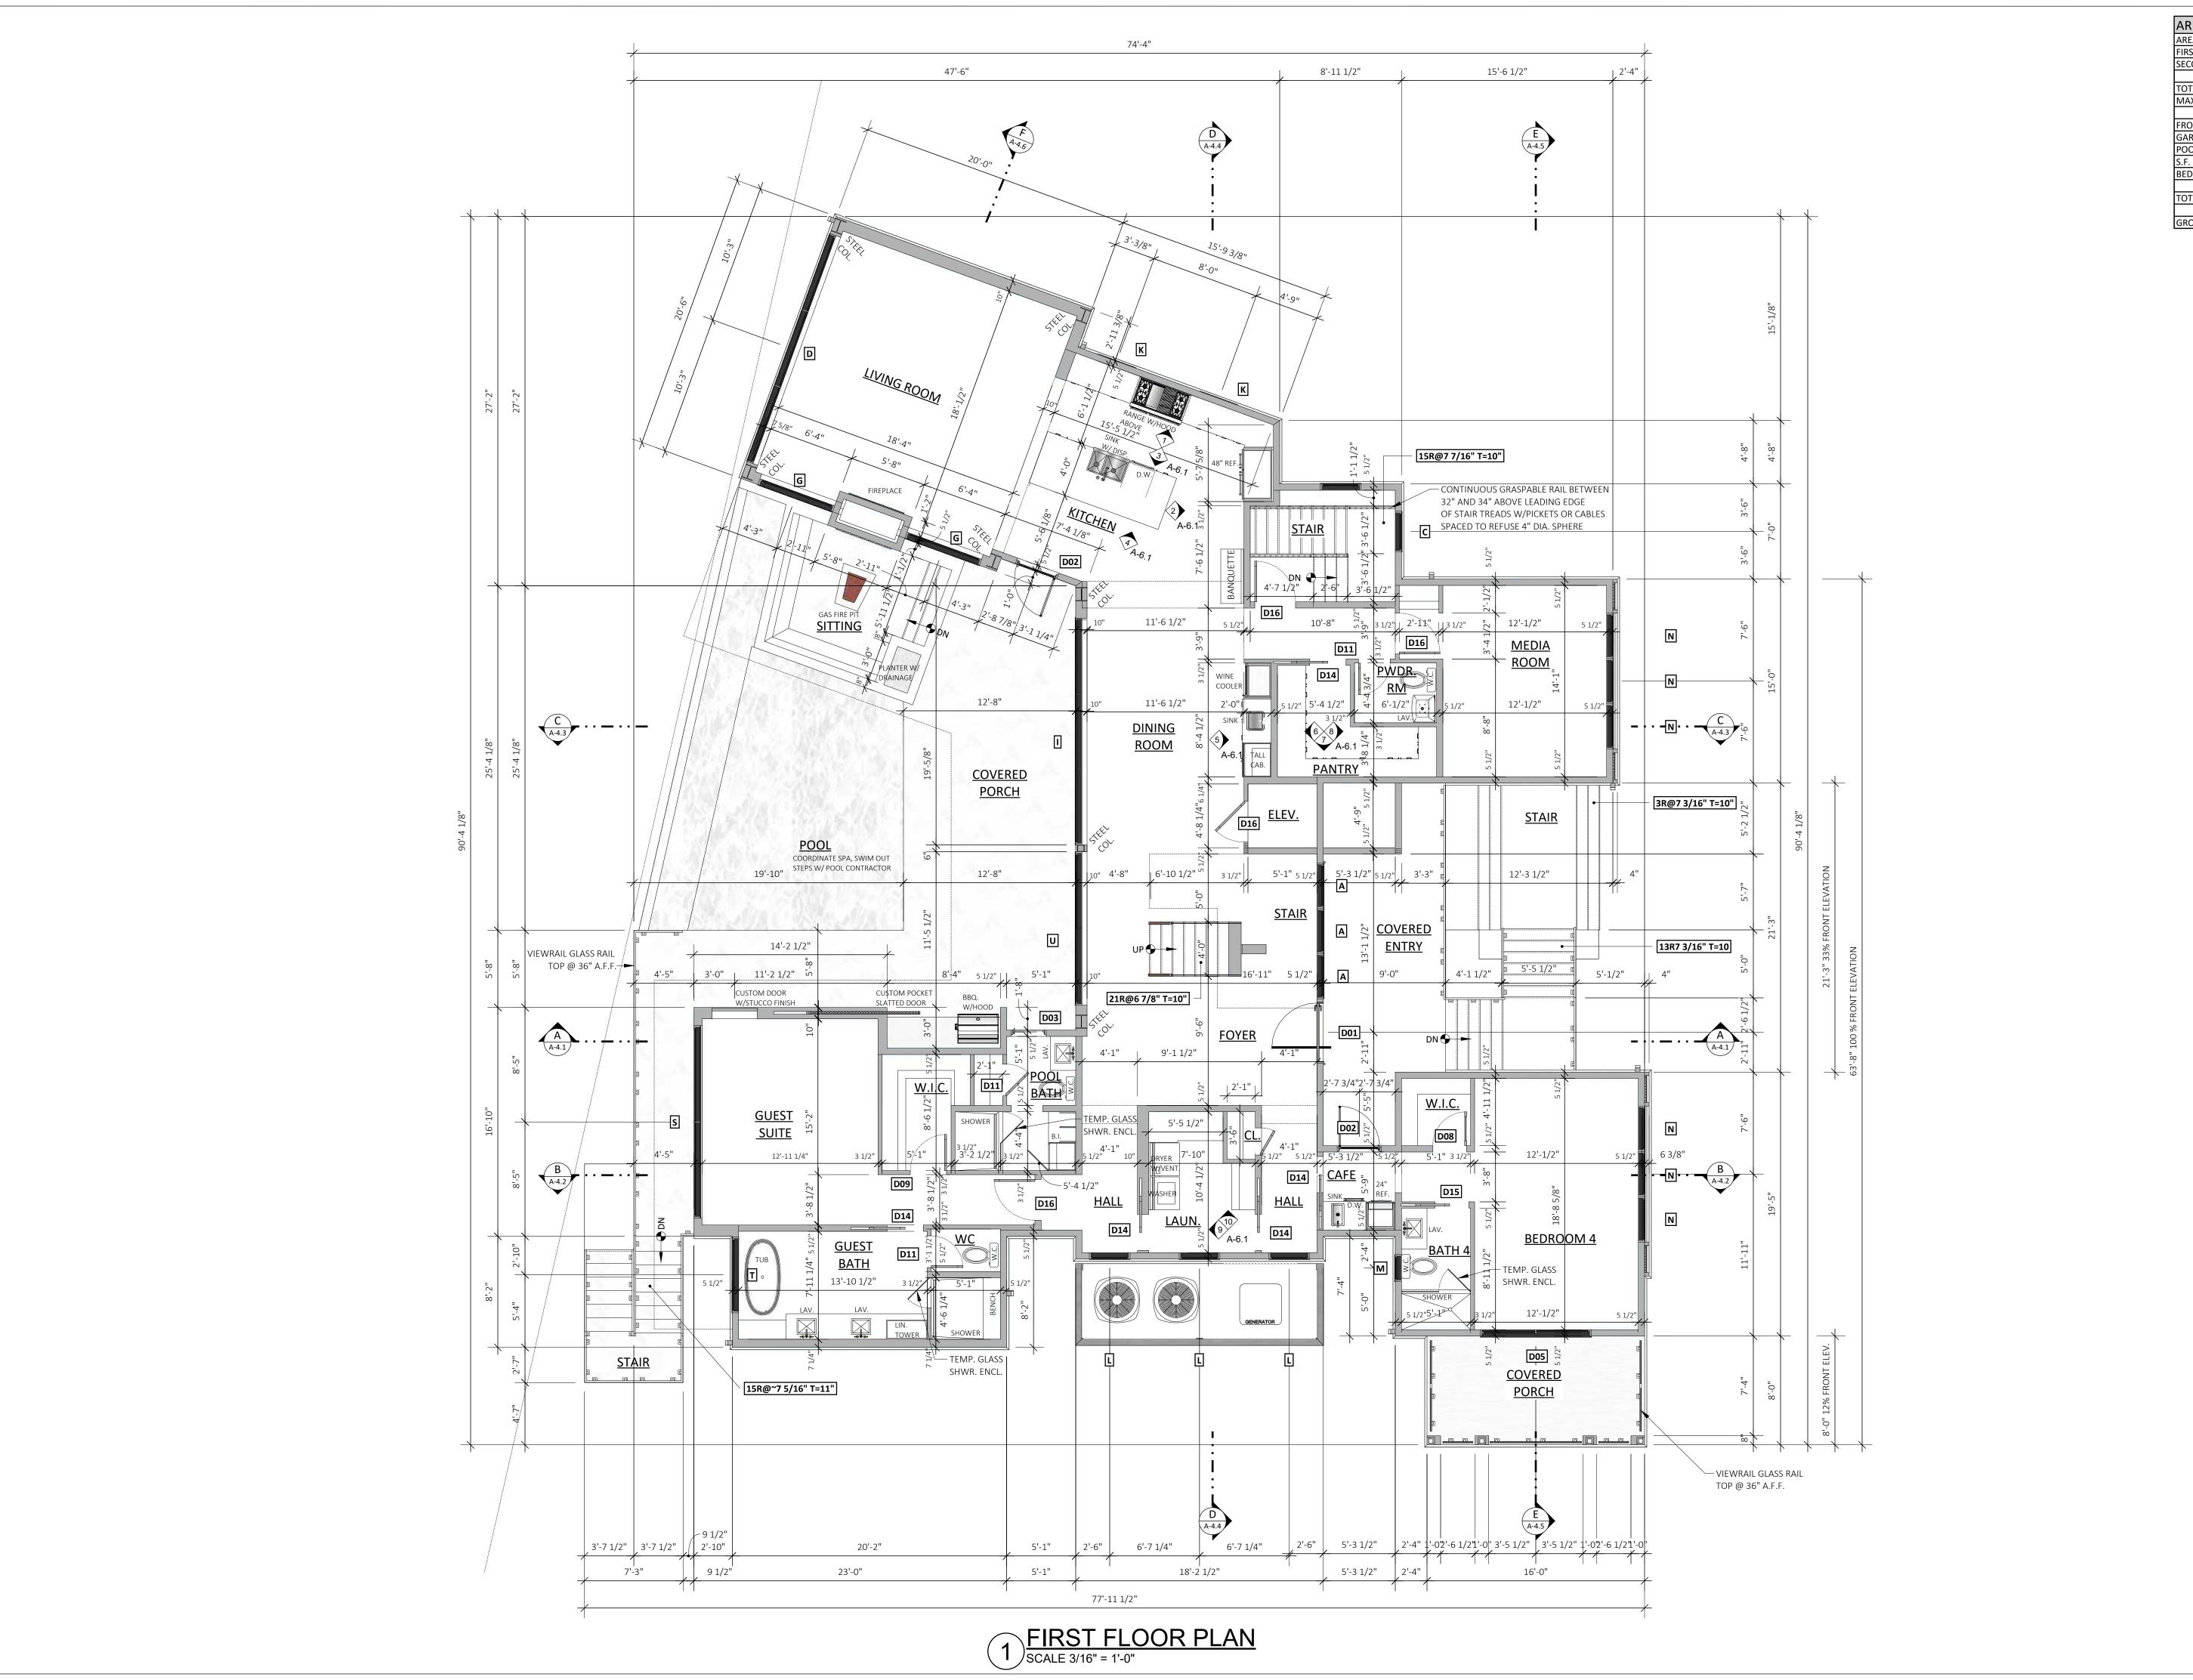

AREA CALCULATIONS AREA NAME AREA S.F. FIRST FLOOR SECOND FLOOR TOTAL HEATED MAX. ALLOWED PBSF 4444.9 FRONT PORCH POOL DECK S.F. BALCONY BEDROOM 4 PORCH TOTAL UNHEATED

COPYRIGHT 2024 ALL RIGHTS COPYRIGHT 2024 ALL RIGHTS
RESERVED
IT IS A VIOLATION OF LAW FOR ANY
PERSON, UNLESS ACTING UNDER THE
DIRECTION OF DLB CUSTOM HOME
DESIGN, TO ALTER THIS DOCUMENT.
PRINTED OR ELECTRONIC DRAWINGS
AND DOCUMENTATION MAY NOT BE
REPRODUCED IN ANY FORM WITHOUT
WRITTEN PERMISSION. THIS DRAWING WAS PREPARED AT THE SCALE INDICATED.
INACCURACIES IN THE STATED SCALE MAY BE INTRODUCED WHEN DRAWINGS ARE REPRODUCED BY ANY MEANS. USE THE GRAPHIC SCALE BAR TO DETERMINE THE ACTUAL SCALE.

BARKOWITZ RESIDENCE
ARCHITECTURAL PLANS
3203 MARSHALL BLVD.
SULLIVANS ISLAND
CHARLESTON COUNTY, SC
LOT 1, BLOCK 16,

JOB NO.: DESIGN BY: DRAWN BY:


DATE: 6/18/2025 SCALE: 1/4" = 1'-0" U.N.O.

PLAN

FLOOR FIRST

SHEET NO.

A-2.1

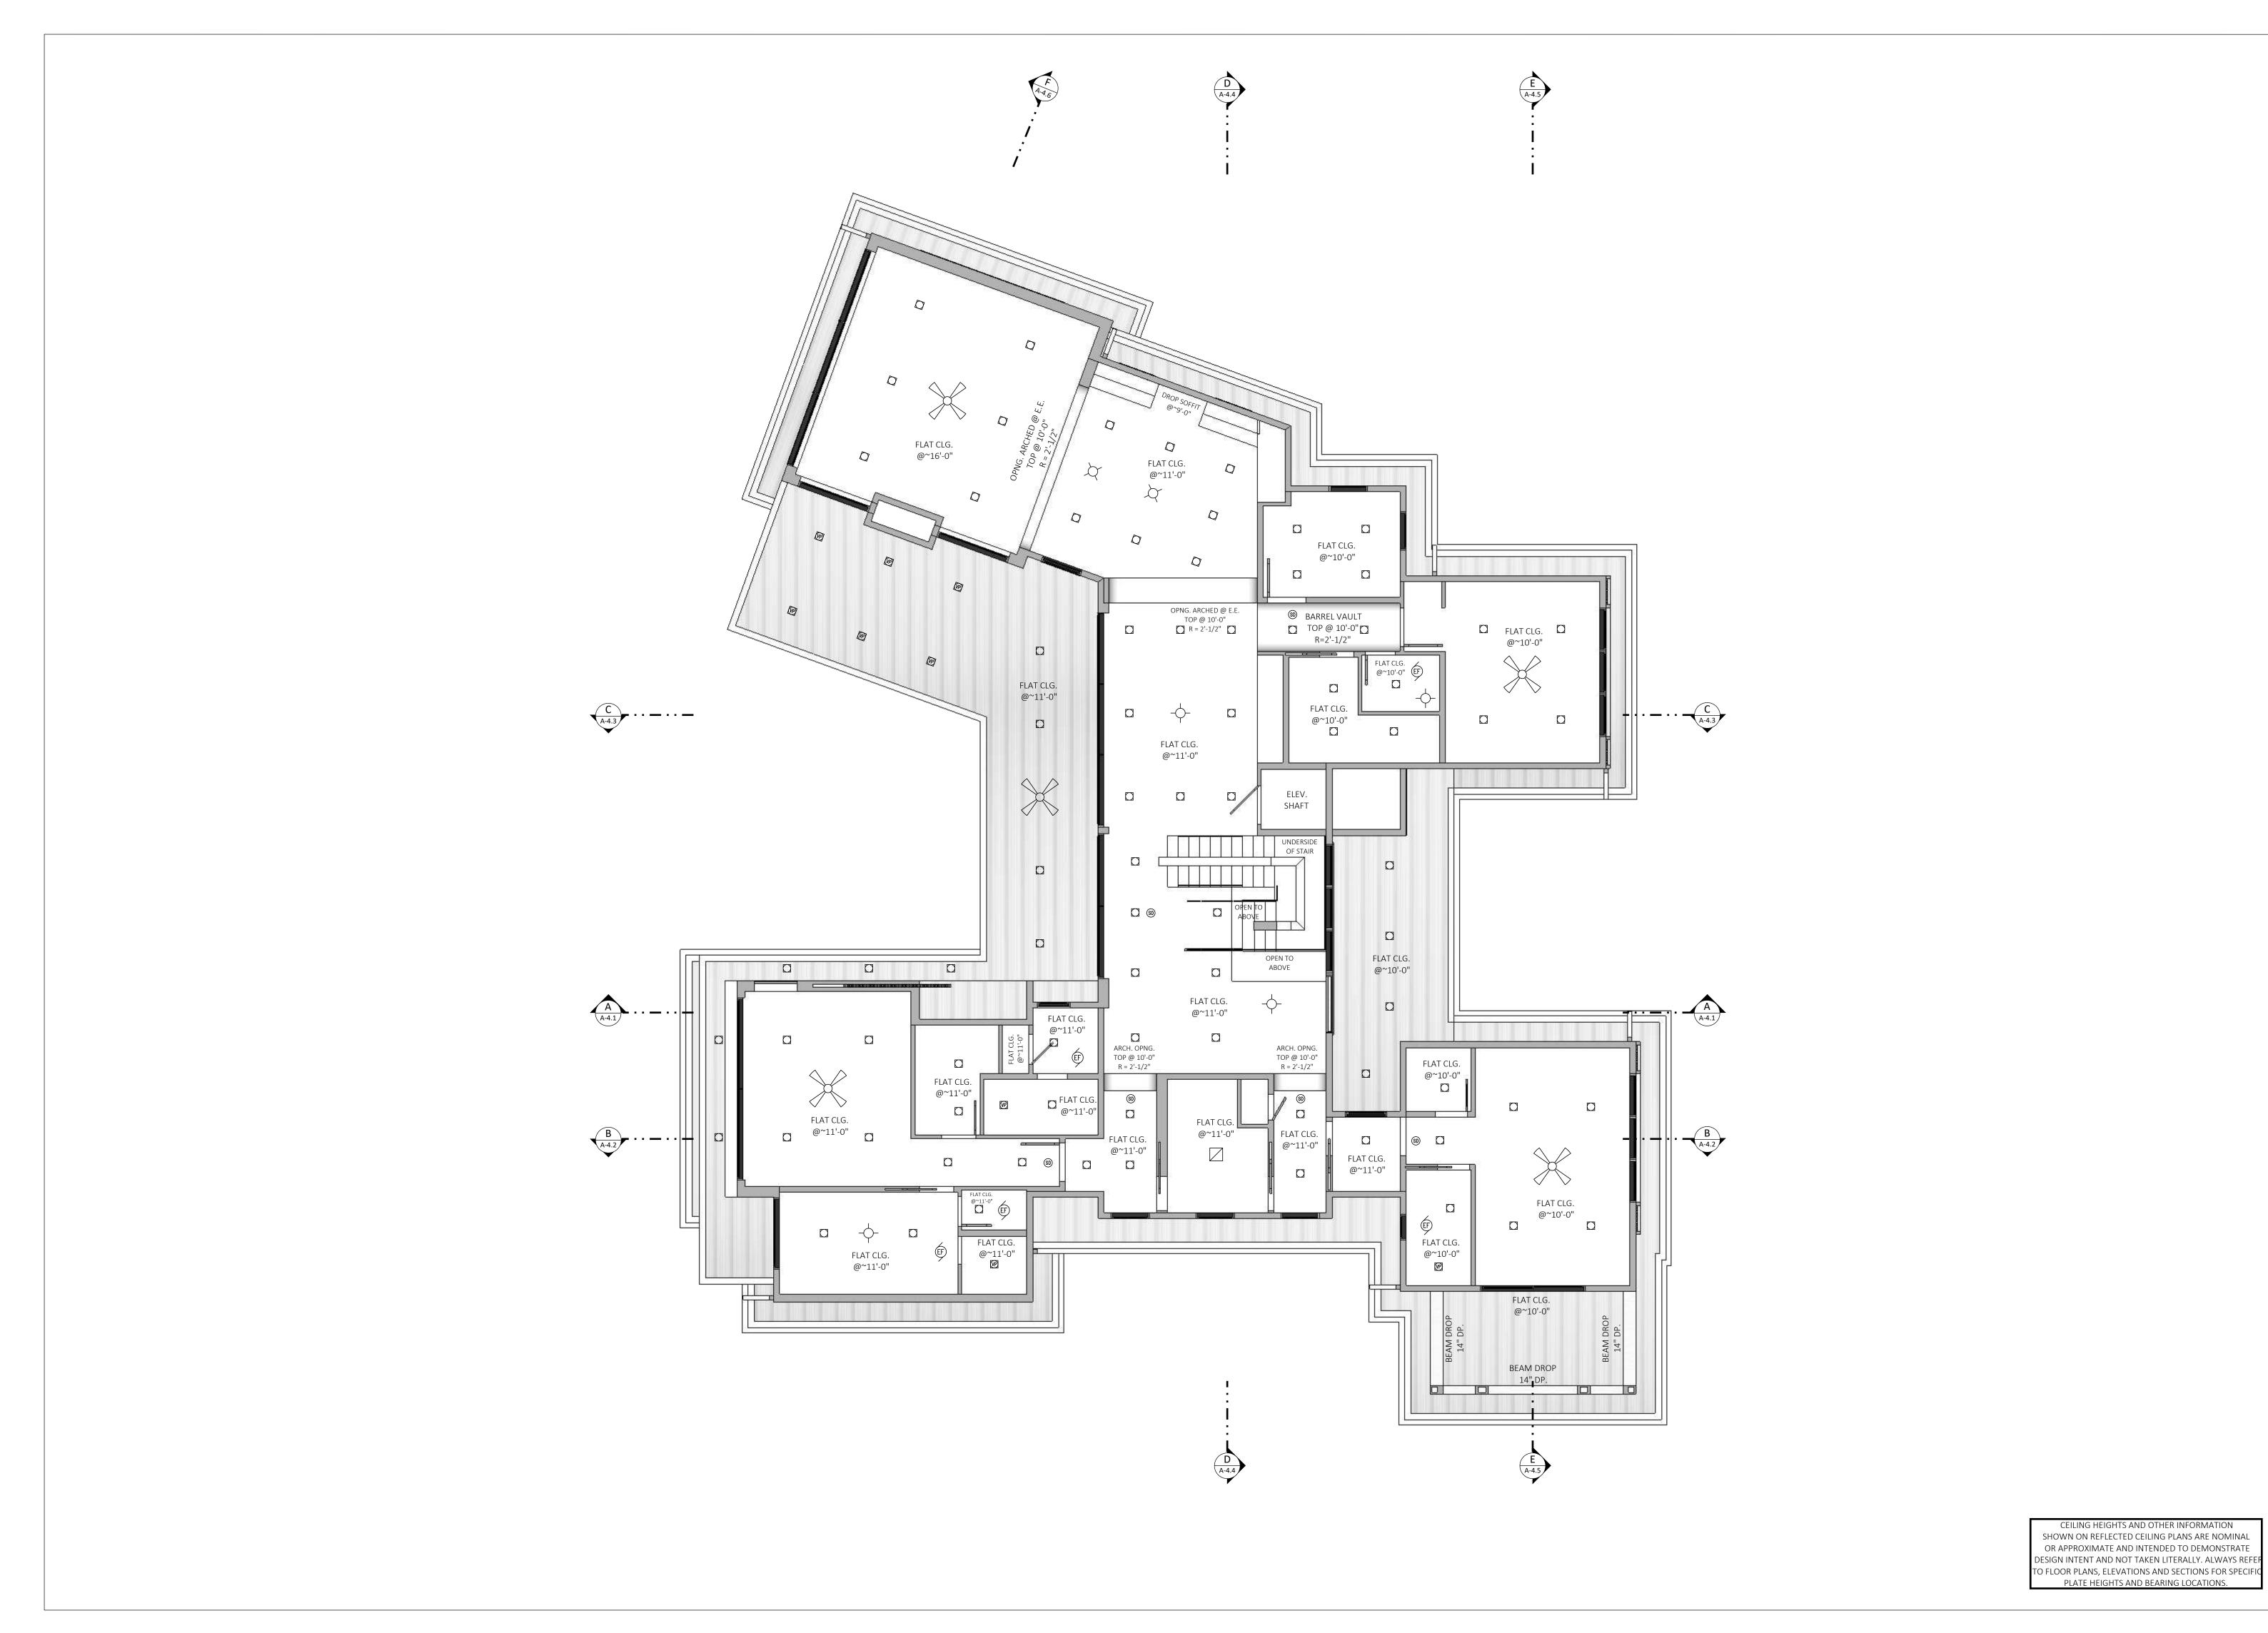

 NO.
 REVISION DESCRIPTION
 DATE

 1
 CONCEPTUAL DESIGN
 07/19/24

 2
 DRB FINAL SUBMITTAL
 01/15/25

 3
 BID SET
 01/29/25

 4
 PERMIT REVIEW SET
 03/20/25

 5
 PERMIT COMMENTS
 06/04/25

 6
 PERMIT COMMENTS
 7/3/2025

SOUTH AN SOUTH AN SCAPE AR. 9183

COPYRIGHT 2024 ALL RIGHTS
RESERVED
IT IS A VIOLATION OF LAW FOR ANY
PERSON, UNLESS ACTING UNDER THE
DIRECTION OF DLB CUSTOM HOME
DESIGN, TO ALTER THIS DOCUMENT.
PRINTED OR ELECTRONIC DRAWINGS
AND DOCUMENTATION MAY NOT BE
REPRODUCED IN ANY FORM WITHOUT
WRITTEN PERMISSION.
THIS DRAWING WAS PREPARED AT
THE SCALE INDICATED.
INACCURACIES IN THE STATED
SCALE MAY BE INTRODUCED WHEN
DRAWINGS ARE REPRODUCED BY
ANY MEANS. USE THE GRAPHIC
SCALE BAR TO DETERMINE THE
ACTUAL SCALE.

MAIL: DLBCUSTOMHOMEDESIGN@GMAIL.COM
WWW.DLBCUSTOMHOMEDESIGN.COM

DALY AND SAWYER

CONSTRUCTION CO

855 COLEMAN BLVD

MT. PLEASANT SC 29464

BARKOWITZ RESIDENCE
ARCHITECTURAL PLANS
3203 MARSHALL BLVD.
SULLIVANS ISLAND
CHARLESTON COUNTY, SC
LOT 1, BLOCK 16,

JOB NO.: 2411

DESIGN BY: DLB

DRAWN BY: DLB


DATE: 6/18/2025 SCALE: 1/4" = 1'-0" U.N.O.


T FLOOR LECTED

SHEET TITLE:
FIRST FLOO
REFLECTEI

SHEET NO.

A-2.1.1

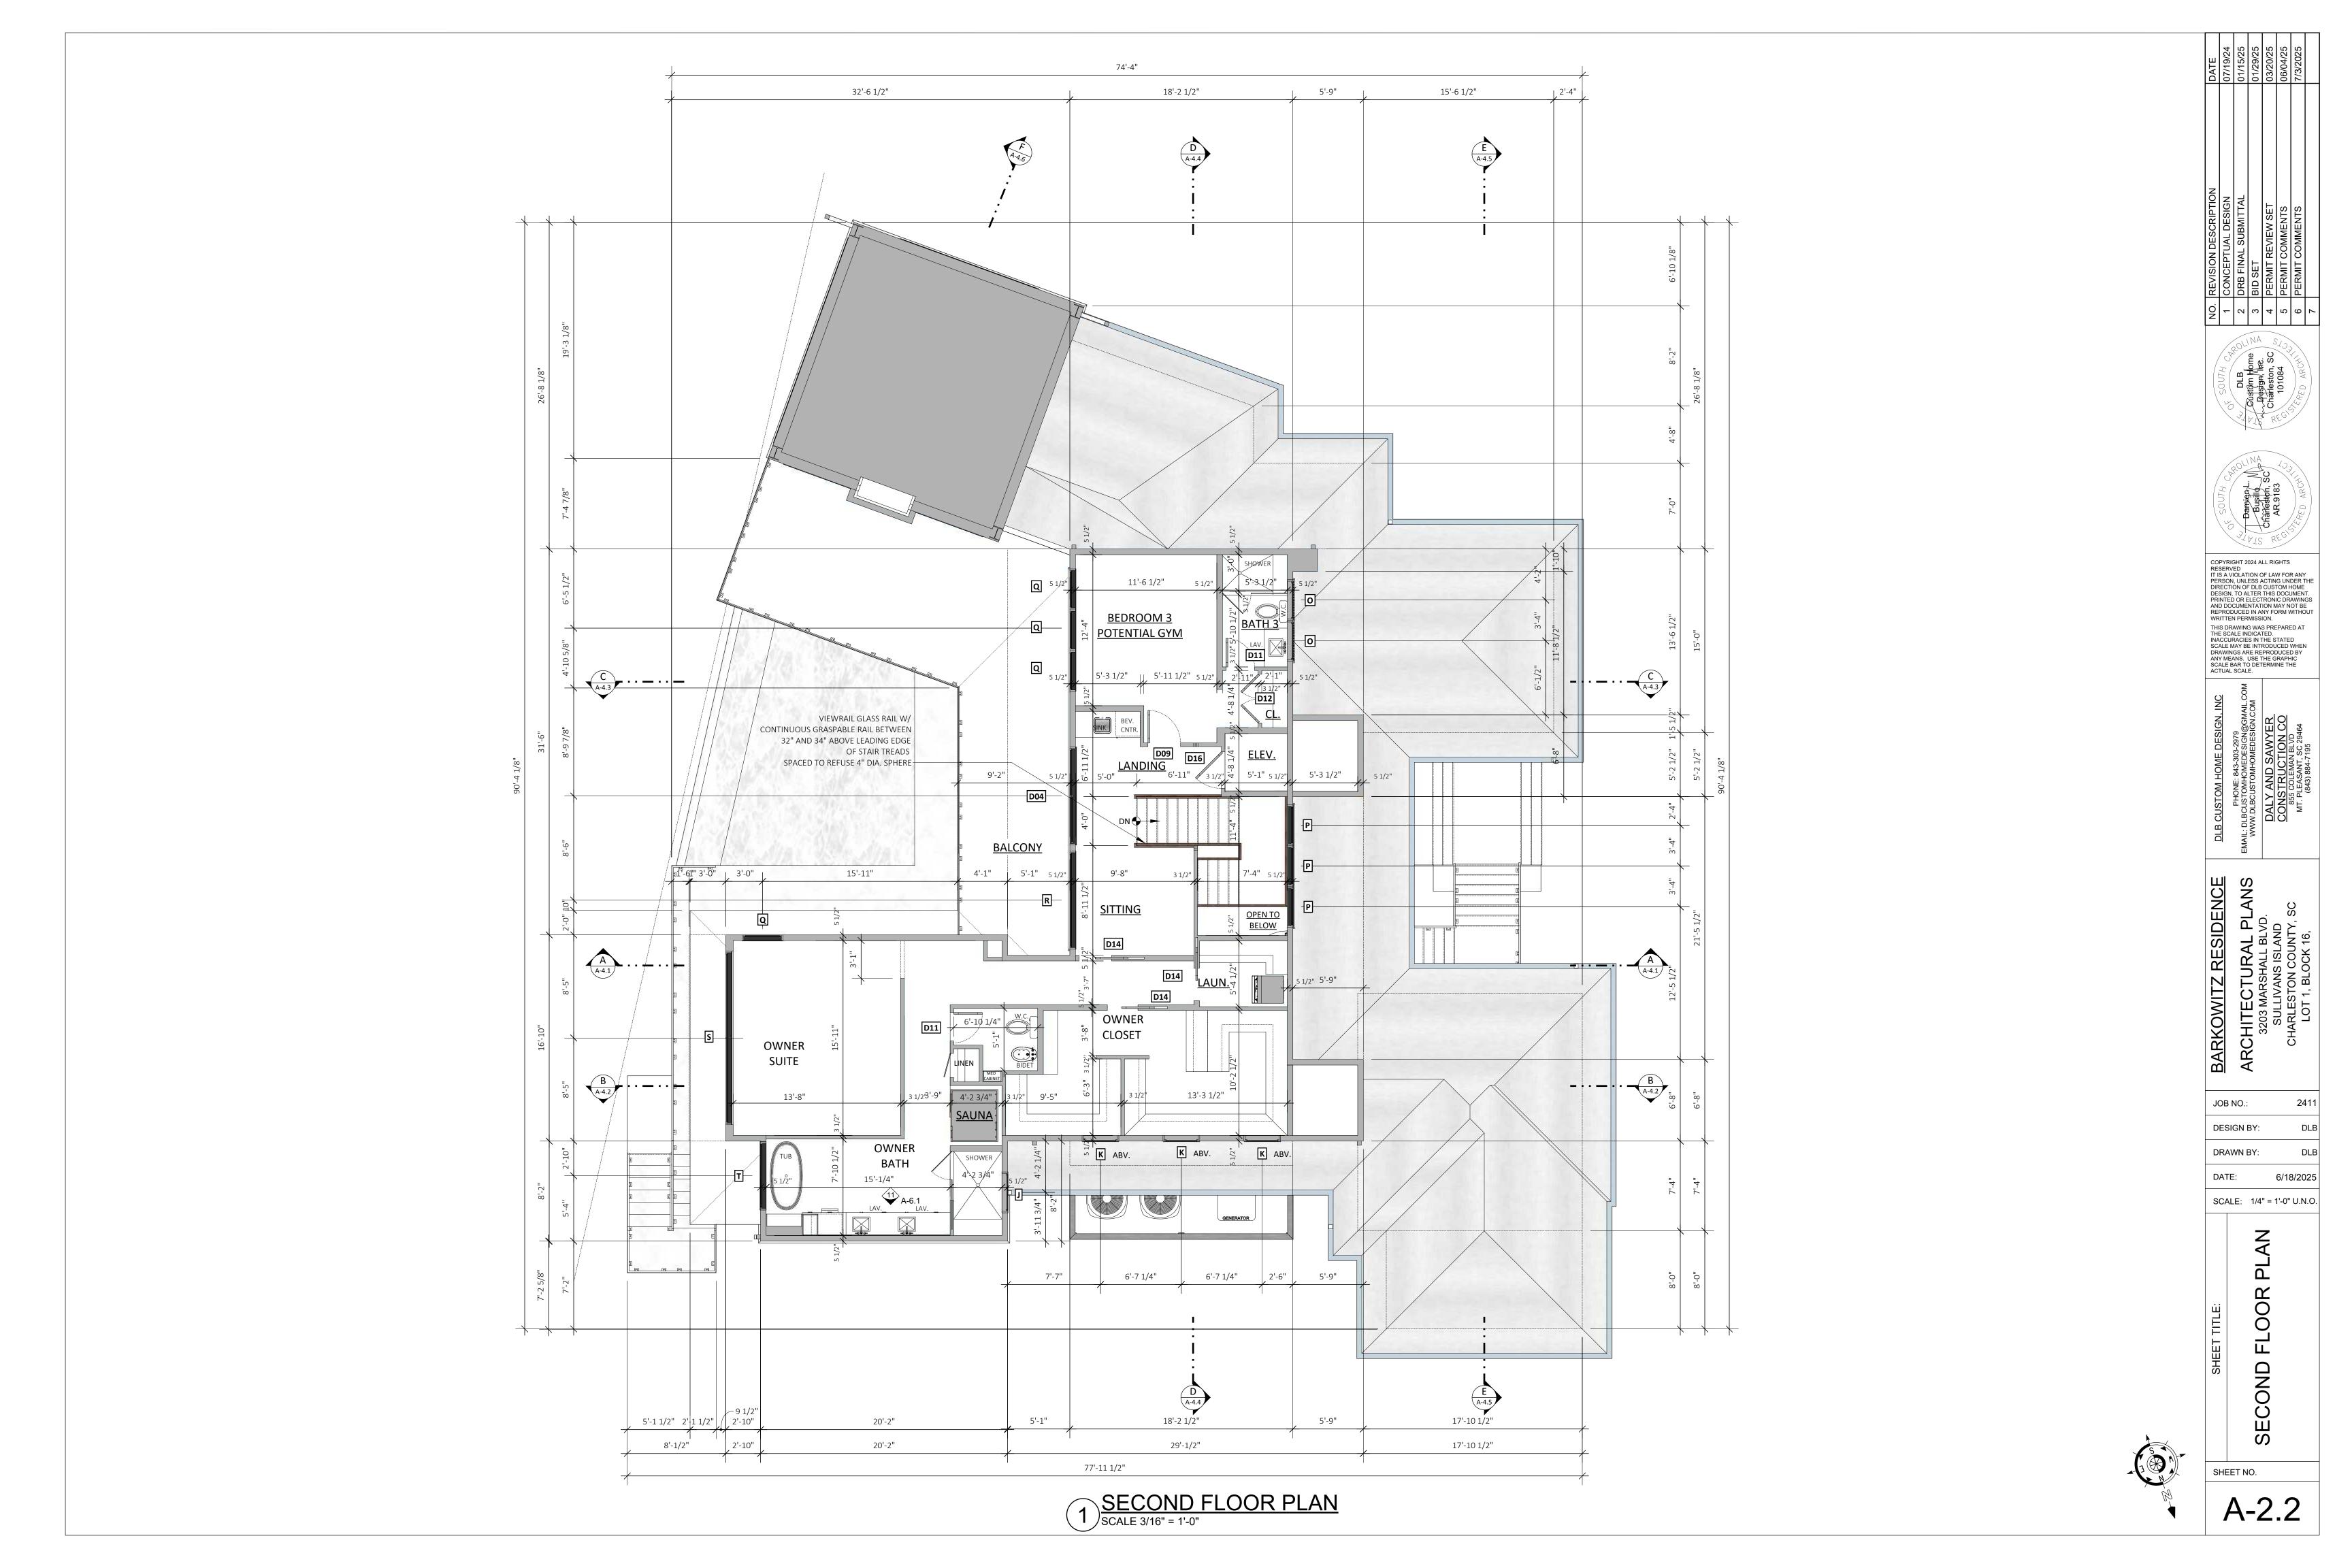

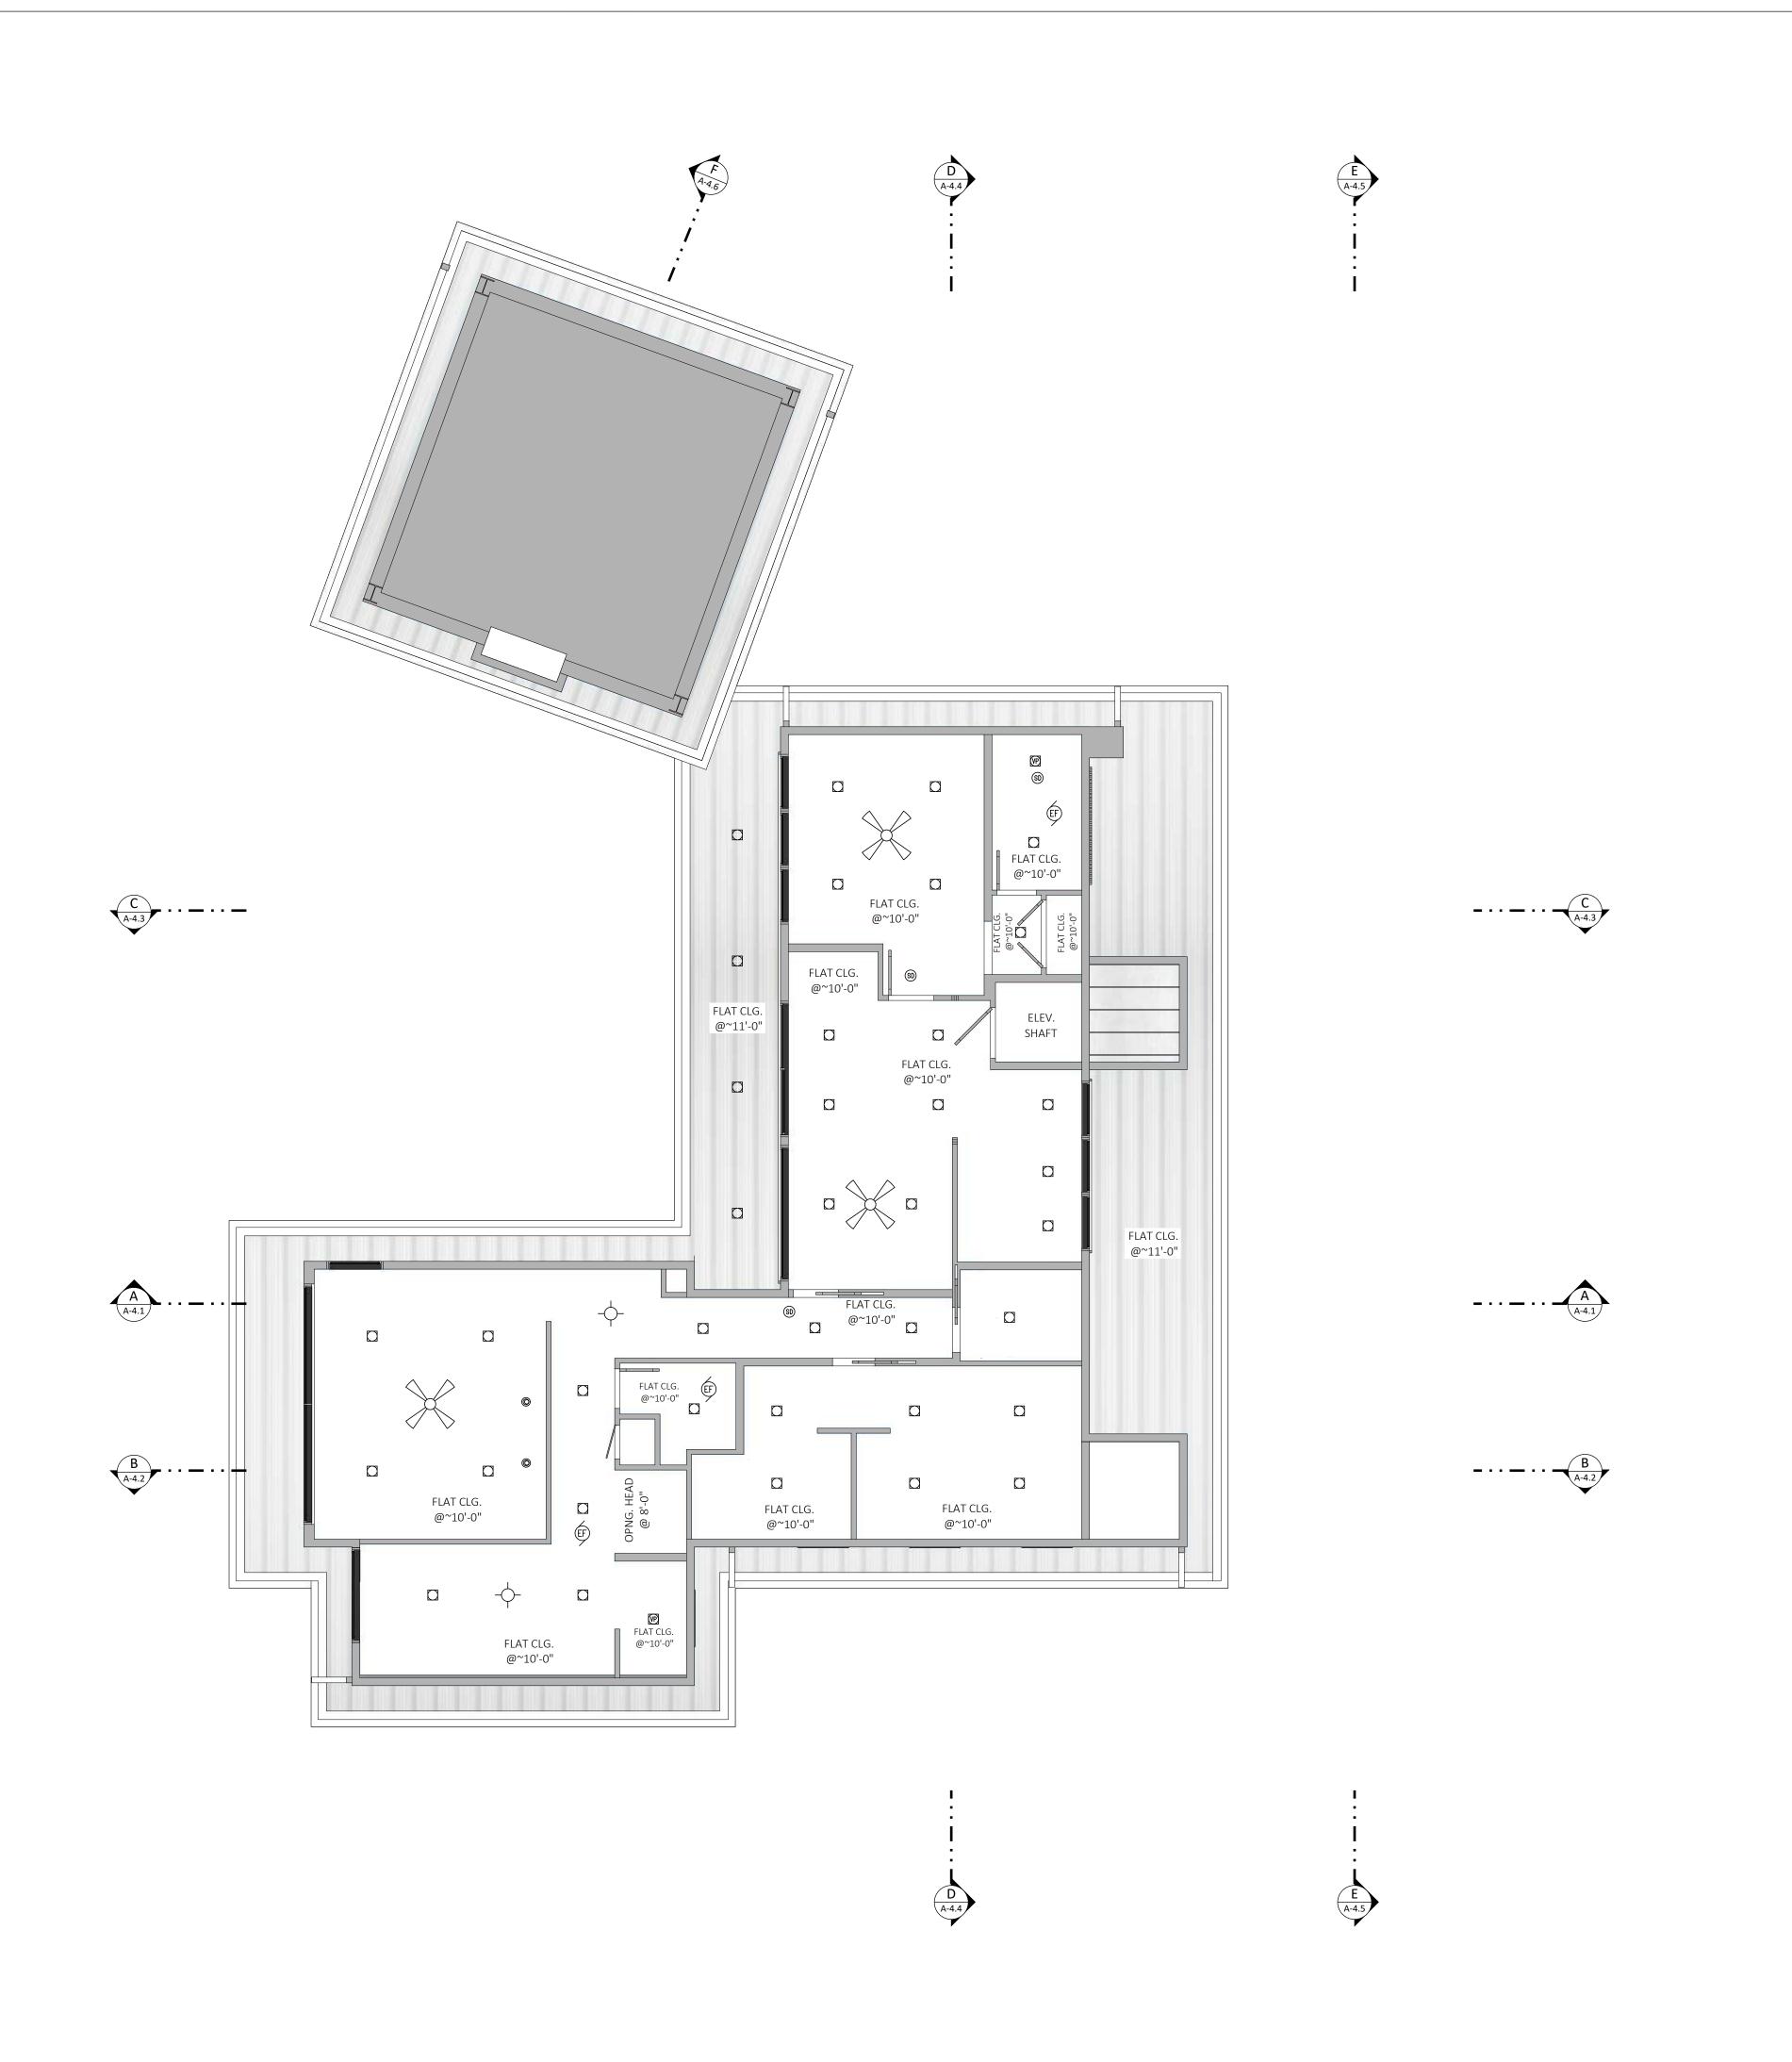

 IO.
 REVISION DESCRIPTION
 DATE

 1
 CONCEPTUAL DESIGN
 07/19/24

 2
 DRB FINAL SUBMITTAL
 01/15/25

 3
 BID SET
 01/29/25

 4
 PERMIT REVIEW SET
 03/20/25

 5
 PERMIT COMMENTS
 06/04/25

 6
 PERMIT COMMENTS
 7/3/2025

 7
 TOWNSON
 7/3/2025





COPYRIGHT 2024 ALL RIGHTS
RESERVED
IT IS A VIOLATION OF LAW FOR ANY
PERSON, UNLESS ACTING UNDER THE
DIRECTION OF DLB CUSTOM HOME
DESIGN, TO ALTER THIS DOCUMENT.
PRINTED OR ELECTRONIC DRAWINGS
AND DOCUMENTATION MAY NOT BE
REPRODUCED IN ANY FORM WITHOUT
WRITTEN PERMISSION.
THIS DRAWING WAS PREPARED AT
THE SCALE INDICATED.
INACCURACIES IN THE STATED
SCALE MAY BE INTRODUCED WHEN
DRAWINGS ARE REPRODUCED BY
ANY MEANS. USE THE GRAPHIC
SCALE BAR TO DETERMINE THE
ACTUAL SCALE.

BARKOWITZ RESIDENCE

ARCHITECTURAL PLANS
3203 MARSHALL BLVD.
SULLIVANS ISLAND
CHARLESTON COUNTY, SC
LOT 1, BLOCK 16,

JOB NO.: 2411

DESIGN BY: DLB

DRAWN BY: DLB

DATE: 6/18/2025


SCALE: 1/4" = 1'-0" U.N.O.

SHEET TITLE:
COND FLOOR
REFLECTED

CEILING HEIGHTS AND OTHER INFORMATION
SHOWN ON REFLECTED CEILING PLANS ARE NOMINAL
OR APPROXIMATE AND INTENDED TO DEMONSTRATE
DESIGN INTENT AND NOT TAKEN LITERALLY. ALWAYS REFER
TO FLOOR PLANS, ELEVATIONS AND SECTIONS FOR SPECIFIC
PLATE HEIGHTS AND BEARING LOCATIONS.

O

A-2.2.1

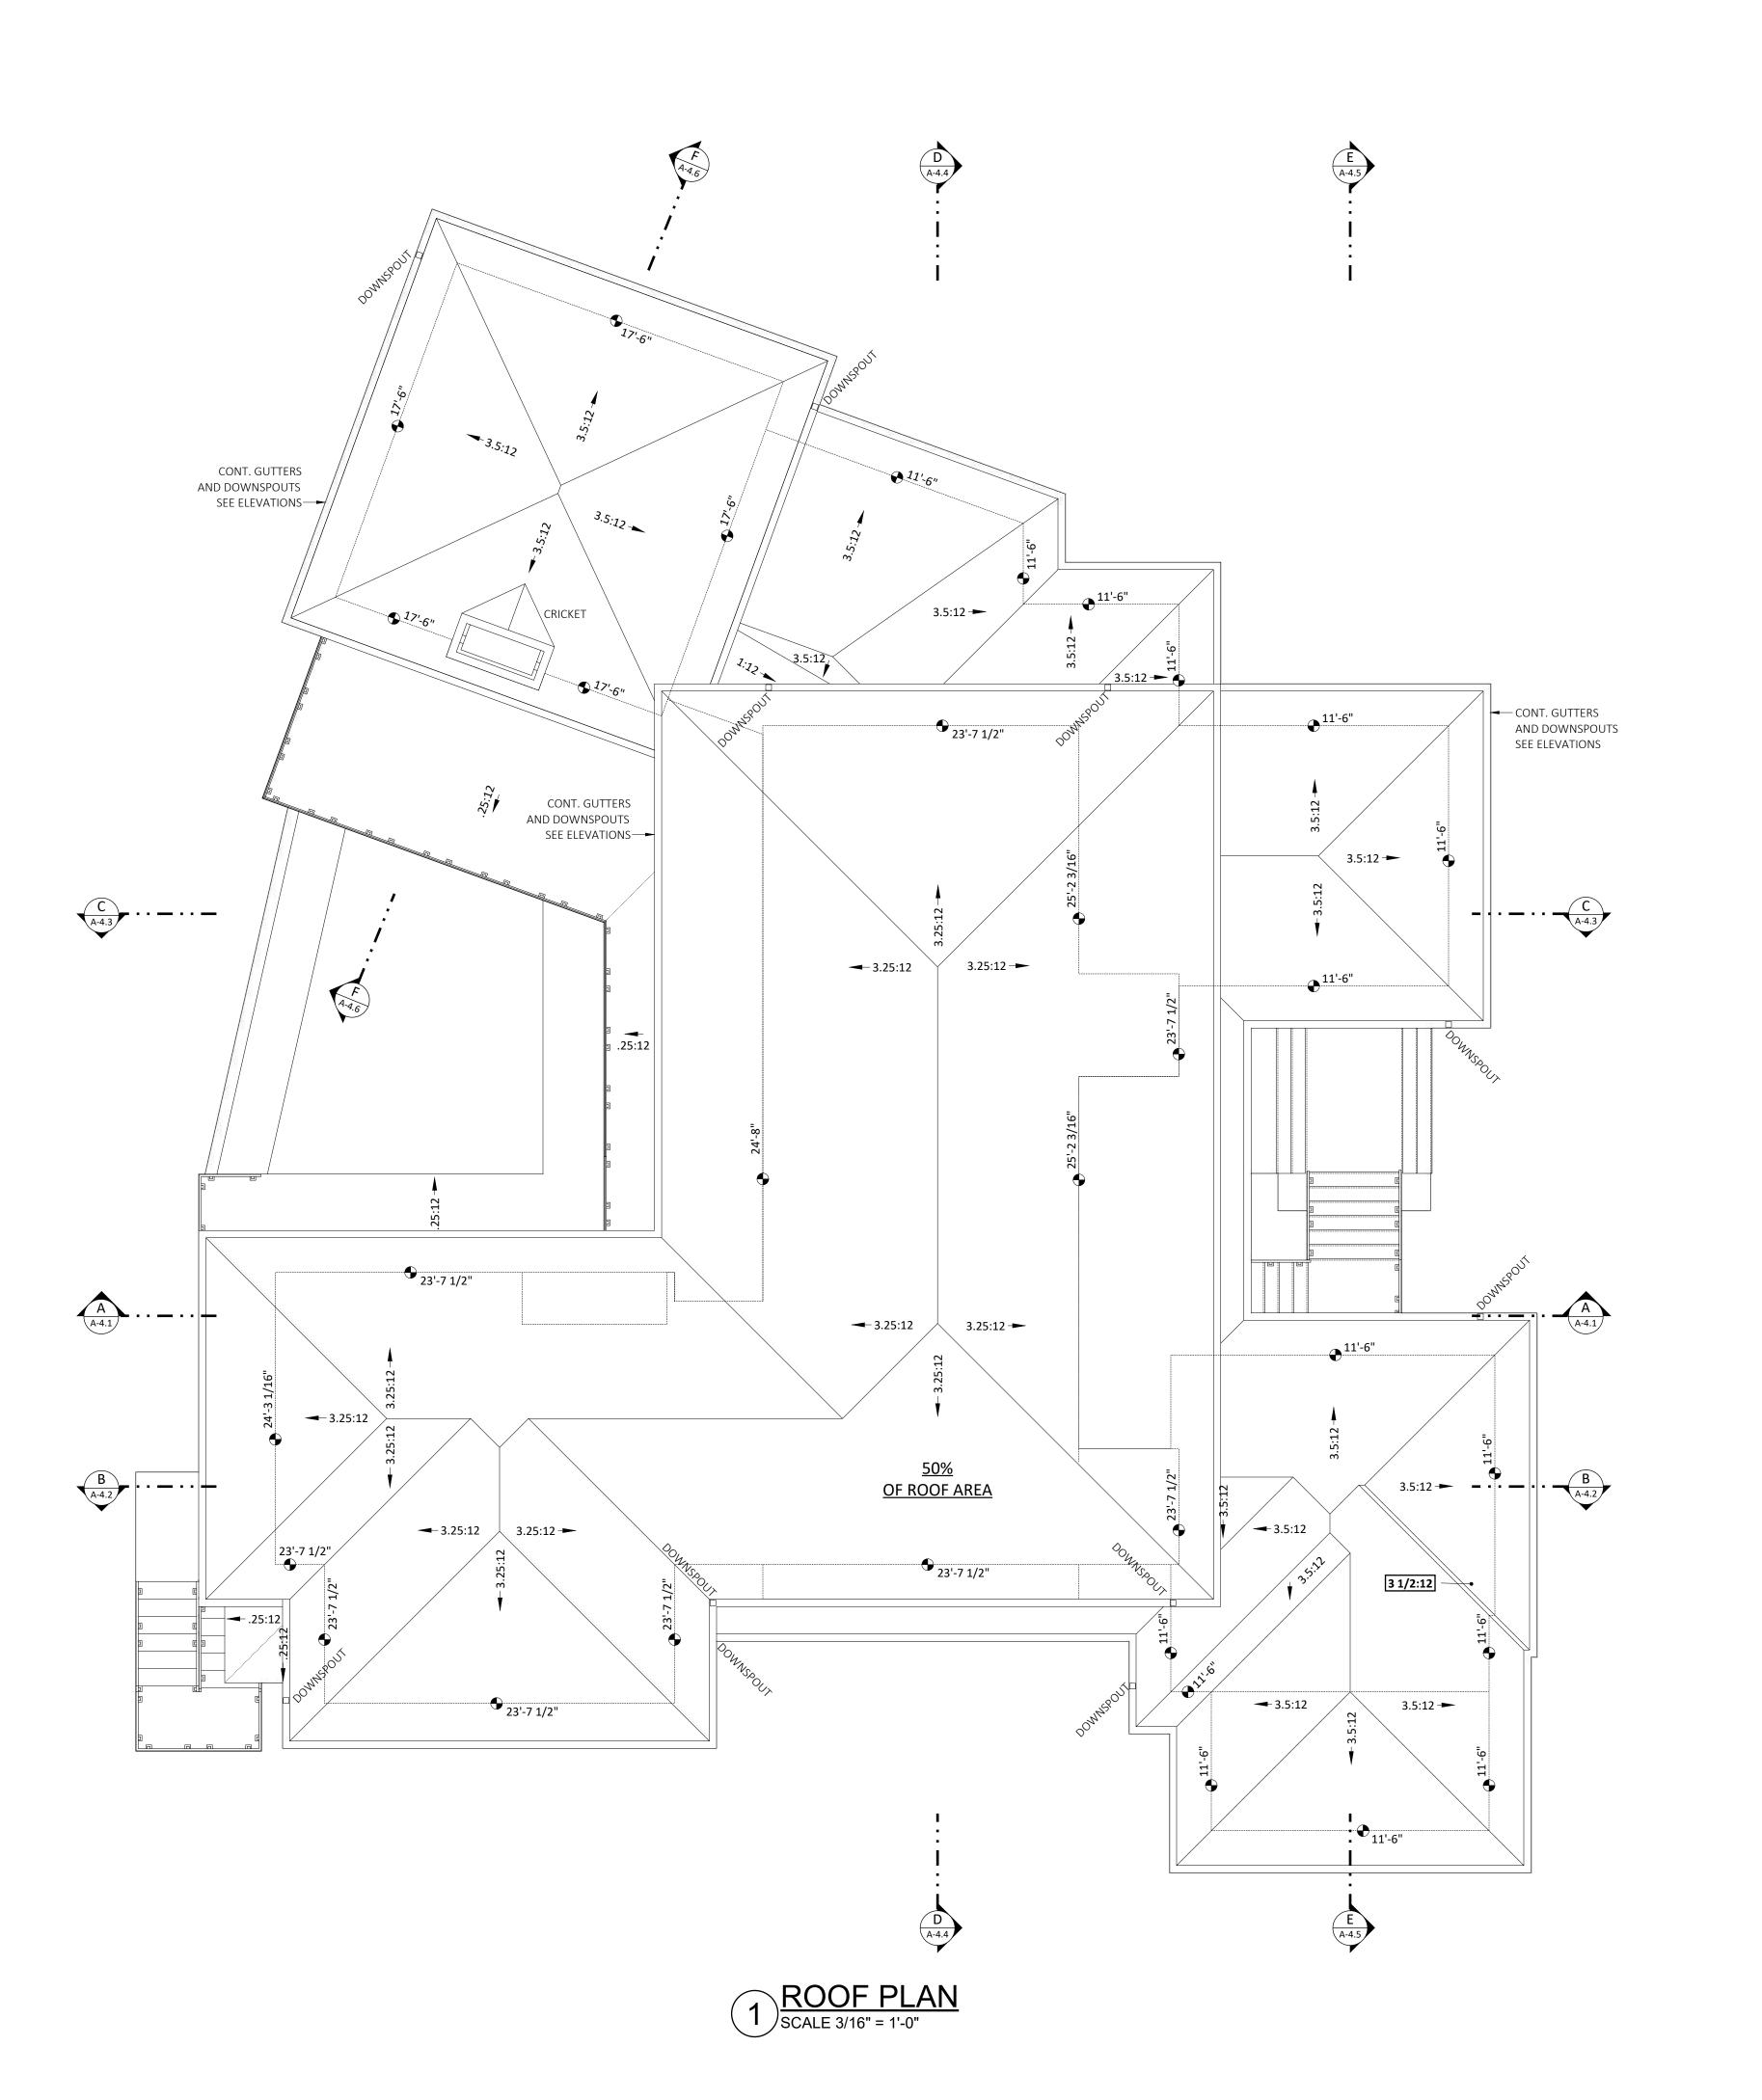

ROOF PLAN NOTES

1. HEIGHTS GIVEN ON THIS PLAN ARE FROM 0'-0" TOP OF FIRST FLOOR SUB-FLOOR.

NEGATIVE NUMBERS ARE BELOW THE FIRST FLOOR DATUM.

UNLESS NOTED OTHERWISE.

2. PLATE HEIGHTS ON ROOF PLANS ARE CALCULATED

UNLESS NOTED OTHERWISE.

2. PLATE HEIGHTS ON ROOF PLANS ARE CALCULATED
USING 2x10 RAFTERS WITH 2 1/4" BIRDS MOUTH
OR INSIDE FACE OF STUD WHICH EVER IS LESS. FOR 2x8
RAFTERS PLATE HEIGHTS ARE CALCULATED USING 1 3/4"
BIRDS MOUTH OR INSIDE OF STUD WHICH EVER IS LESS.

ROOF AREA CALCULATION	
MAIN ROOF AREA	2424 S.F.
OTHER ROOF AREA	2424 S.F.
TOTAL ROOF AREA	4848 S.F.
MAIN ROOF AS PERCENTAGE	
2424/4887 =	50%

NO. REVISION DESCRIPTION

1 CONCEPTUAL DESIGN

2 DRB FINAL SUBMITTAL

3 BID SET

4 PERMIT REVIEW SET

5 PERMIT COMMENTS

6 PERMIT COMMENTS

7





COPYRIGHT 2024 ALL RIGHTS
RESERVED
IT IS A VIOLATION OF LAW FOR ANY
PERSON, UNLESS ACTING UNDER THE
DIRECTION OF DLB CUSTOM HOME
DESIGN, TO ALTER THIS DOCUMENT.
PRINTED OR ELECTRONIC DRAWINGS
AND DOCUMENTATION MAY NOT BE
REPRODUCED IN ANY FORM WITHOUT
WRITTEN PERMISSION.
THIS DRAWING WAS PREPARED AT
THE SCALE INDICATED.
INACCURACIES IN THE STATED
SCALE MAY BE INTRODUCED WHEN
DRAWINGS ARE REPRODUCED BY
ANY MEANS. USE THE GRAPHIC
SCALE BAR TO DETERMINE THE
ACTUAL SCALE.

PHONE: 843-303-2979

EMAIL: DLBCUSTOMHOMEDESIGN@GMAIL.CON
WWW.DLBCUSTOMHOMEDESIGN.COM

DALY AND SAWYER

CONSTRUCTION CO

855 COLEMAN BLVD

MT. PLEASANT, SC 29464

(843) 884-7195

AKKOWIIZ KESIDENCE

RCHITECTURAL PLANS
3203 MARSHALL BLVD.
SULLIVANS ISLAND
CHARLESTON COUNTY, SC

JOB NO.: 2411

DESIGN BY: DLB

DRAWN BY: DLB

DATE: 6/18/2025 SCALE: 1/4" = 1'-0" U.N.O.

SCALE: 1/4" = 1'-0" U.I

SHEET TITLE:
ROOF PLAN

SHEET NO.

SHEET NO.

4-2.3

Description	CNAME	IADE A	TELOOD	IDAGE	IOEU IN	10		I C D C \ A \ A \	TAVAINIOCOT	INOTE		1
PATH 46 TLE	E NAME OOM 4											
CAFE 33 HARDWOOD 1410 DRYWALL 2 PIECE NO CUSTOM CASEWORK PROVIDE SHOP DRAWING DOS COUSER DOWN SHOP DRAWING DOS DRYWALL	OOM 4 > BATH 4											
CLOSET 25 HARDWOOD 1410 DRYWALL 2 PECE NO ROD AND SHELF DO AN	OOM 4 > CAFE									_	DK DDOVIDE SHOD DDAWING	
COVERED PORCH 188	OOM 4 > CAPE OOM 4 > CLOSET										RK PROVIDE SHOP DRAWING	
The color The												
TITY	RD PORCH											
232 HARDWOOD 1310 DRYWALL 2 PIECE NO NONE DRYWALL	RED ENTRY											
PAPE	G ROOM											
101	TOR SHAFT						ΡΥ\Λ/ΔΙΙ					
1329 HARDWOOD 1x10 DRYWALL 2 PIECE NO NONE	ALL						KIVVALL					
239	₹											
□ COSET 49 HARDWOOD 1x10 DRYWALL 2 PIECE NO CUSTOM CASEWORK PROVIDE SHOP DRAWING D15	SUITE											
SQUEST BATH	SUITE > CLOSET									_	RK PROVIDE SHOP DRAWING	
ET	SUITE > GUEST BATH											
274	CLOSET											
ANTRY 67	EN										RK PROVIDE SHOP DRAWING	1
16	EN > PANTRY											DOOF
345	DRY											1.
187 HARDWOOD 1x10 DRYWALL 2 PIECE NO CUSTOM CASEWORK PROVIDE SHOP DRAWING VESTIBULE 42 HARDWOOD 1x10 DRYWALL 2 PIECE NO NONE NO NONE NO NONE NO NO	ROOM	345			DRYW	ALL		2 PIECE	NO	NONE		AND
1	ROOM		HARDWOOD		DRYW	ALL			NO		RK PROVIDE SHOP DRAWING	_
167 NATURAL STONE NO BASE NONE NO NONE NO CLOSET TILE 1x10 DRYWALL 2 PIECE NO CUSTOM CASEWORK PROVIDE SHOP DRAWING OF SHELVES CLOSET 8 TILE 1x10 DRYWALL NONE NO 5 SHELVES CLOSET SHELVES SHELVES CLOSET SHE	ROOM > VESTIBULE					ALL						
CLOSET 8	DECK	167										3.
A	BATH	67									RK PROVIDE SHOP DRAWING	DOOF
ON 27 TILE	BATH > CLOSET	8										
SECOND FLOOR ROOM FINISH SCHEDULE SECOND FLOOR ROOM FINISH SCHEDULE	ER ROOM											
SECOND FLOOR ROOM FINISH SCHEDULE	F.F. TO G.F.	89	HARDWOOD	1x10	DRYW	ALL		1 PIECE	NO	NONE		
AREA FLOOR				SECOND F	I OOR	ROOM F	INISH SCI	HEDLILE				, ·
AREA FLOOR BASE CELLING CROWN WAINSCOT NOTE	- NIANAT	IADEA IE		<u>JECOND I</u>					A/NI IVA/AINICO	OT INOTE		-1 7.
175 HARDWOOD	E NAME ONY											┤ ``
SATH 3	OOM 3			PE WOOD DE	CKING							- 8.
CLOSET 10 HARDWOOD 1x8 DRYWALL NONE NO ROD AND SHELF 68 HARDWOOD 1x8 DRYWALL 1 PIECE NO NONE TIE 218 WATERPROOFING WITH IPE WOOD DECKING NO BASE Tis DECKING 1 PIECE NO NONE TIE > CLOSET 219 HARDWOOD 1x8 DRYWALL 1 PIECE NO CUSTON CASEWORK PROVIDE SHOP DRAWING TIE > CONNERS BATH 225 TILE 1x8 DRYWALL 1 PIECE NO COORDINATE ALL FINISHES W/ SAUNA MFR. ALLO TIE > SAUNA 21 COORDINATE WITH SANA MFR. NO BASE NOBASE NONE NO COORDINATE ALL FINISHES W/ SAUNA MFR. ALLO MY 4.2 TILE 1x8 DRYWALL NONE NO COORDINATE ALL FINISHES W/ SAUNA MFR. ALLO MIM 182 HARDWOOD 1x8 DRYWALL NONE NO NONE ALLO ALLO ALLO ALLO ALLO ALLO ALLO ALLO <td>OOM 3 > BATH 3</td> <td></td> <td>┨</td>	OOM 3 > BATH 3											┨
68 HARDWOOD 1x8 DRYWALL 1PIECE NO NONE	OOM 3 > CLOSET											-
TE 218 WATERPROOFING WITH IPE WOOD DECKING NO BASE TAG DECKING 1 PIECE NO NONE TE > CLOSET 219 HARDWOOD 1x8 DRYWALL 1 PIECE NO NONE TE > SAUNA 21 COORDINATE WITH SANA MFR. NO BASE NONE NONE NO COORDINATE ALL FINISHES W SAUNA MFR. Y 42 TILE 1x8 DRYWALL 2 PIECE NO NONE MM 182 HARDWOOD 1x8 DRYWALL 2 PIECE NO NONE GROUND FLOOR ROOM FINISH SCHEDULE E FRONT PORCH 161 BRICK PAVERS NO BASE TAG DECKING 1 PIECE NO NONE OM 65 TILE 1x8 SKF FIRERATED DRYWALL 1 PIECE NO NONE ALLO ALLO	NG										.1	
ITE > CLOSET 219 HARDWOOD 1x8 DRYWALL 1 PIECE NO CUSTOM CASEWORK PROVIDE SHOP DRAWING THE > OWNERS BATH 225 TILE 1x8 DRYWALL 1 PIECE NO NONE TIE > SAUNA 21 COORDINATE WITH SANA MFR. NO BASE NONE NONE NO COORDINATE ALL FINISHES W / SAUNA MFR. ALLON NONE Y 42 TILE 1x8 DRYWALL NONE NO PROVIDE FLOOR DRAWIN AND PAN 182 HARDWOOD 1x8 DRYWALL 2 PIECE NO NONE ALLON NONE SET ON NONE NO PROVIDE FLOOR DRAWIN AND PAN ALLON NONE NO NONE ALLON NONE NO NONE NO PROVIDE FLOOR DRAWIN AND PAN ALLON NONE NO NONE NO NONE NO NONE NO PROVIDE FLOOR DRAWIN AND PAN ALLON NONE NO NONE NO NONE NO PROVIDE FLOOR DRAWIN AND PAN ALLON NONE NO	RS SUITE			PE WOOD DE	CKING							
ITE > OWNERS BATH 225 TILE	RS SUITE > CLOSET		14 DD14/0 OD	L WOOD DE		4.0	DD\ (\A\ (\A\)\)				WORK PROVIDE SHOP DRAWING	
ITE > SAUNA 21 COORDINATE WITH SANA MFR. NO BASE NONE NONE NO COORDINATE ALL FINISHES W / SAUNA MFR. ALLON MY 42 TILE 188 DRYWALL NONE NO PROVIDE FLOOR DRAIN AND PAN 182 HARDWOOD 188 DRYWALL 2 PIECE NO NONE NONE NONE NONE MAINS MAIN MAIN MAIN MAIN MAIN MAIN MAIN MAIN	RS SUITE > OWNERS BATH										TOTAL TROUBLE STOP BIGHTING	
TILE	RS SUITE > SAUNA			MFR.							ALL FINISHES W / SAUNA MFR.	
GROUND FLOOR ROOM FINISH SCHEDULE AREA FLOOR BASE CEILING CROWN WAINSCOT NOTE	AUNDRY											
GROUND FLOOR ROOM FINISH SCHEDULE AREA FLOOR BASE CEILING CROWN WAINSCOT NOTE AFRONT PORCH 161 BRICK PAVERS NO BASE T&G DECKING 1 PIECE NO NONE D PATIO 1112 BRICK PAVERS NO BASE T&G DECKING 1 PIECE NO NONE OM 65 TILE 1x8 5/8" FIRERATED DRYWALL 1 PIECE NO CUSTOM B.I. CUBBIES ALLOY	NG ROOM											
AREA FLOOR BASE CEILING CROWN WAINSCOT NOTE REPORT PORCH 161 BRICK PAVERS NO BASE T&G DECKING 1 PIECE NO NONE D PATIO 112 BRICK PAVERS NO BASE T&G DECKING 1 PIECE NO NONE OM 65 TILE 1x8 5/8" FIRERATED DRYWALL 1 PIECE NO CUSTOM B.I. CUBBIES 1 SCHEDULE NOTES: R RESISTANT GYPSUM BOARD CANNOT BE USED FOR WALLS IN SHOWER COMPARTMENTS OR IN AREAS OF HIGH HUMIDITY OR AREAS EXPOSED TO WATER PER ALLO'				CDOLIND								
R FRONT PORCH 161 BRICK PAVERS NO BASE T&G DECKING 1 PIECE NO NONE D PATIO 112 BRICK PAVERS NO BASE T&G DECKING 1 PIECE NO NONE OM 65 TILE 188 5/8" FIRERATED DRYWALL 1 PIECE NO CUSTOM B.I. CUBBIES OM 3174 CONCRETE SEALANT 1x4 5/8" FIRERATED DRYWALL NONE NO NONE R RESISTANT GYPSUM BOARD CANNOT BE USED FOR WALLS IN SHOWER COMPARTMENTS OR IN AREAS OF HIGH HUMIDITY OR AREAS EXPOSED TO WATER PER ALLO ALLO ALLO ALLO ALLO ALLO ALLO ALL								HEDULE				
DPATIO 112 BRICK PAVERS NO BASE T&G DECKING 1 PIECE NO NONE OM 65 TILE 1x8 5/8" FIRERATED DRYWALL 1 PIECE NO CUSTOM B.I. CUBBIES ALLO' 13174 CONCRETE SEALANT 1x4 5/8" FIRERATED DRYWALL NONE NO NONE R RESISTANT GYPSUM BOARD CANNOT BE USED FOR WALLS IN SHOWER COMPARTMENTS OR IN AREAS OF HIGH HUMIDITY OR AREAS EXPOSED TO WATER PER ALLO' ALD' ALLO' ALO' ALLO' ALLO' ALLO' ALLO' ALLO' ALLO' ALLO' ALLO' ALLO'	E NAME											
OM 65 TILE 1x8 5/8" FIRERATED DRYWALL 1 PIECE NO CUSTOM B.I. CUBBIES ALLOY 1x4 5/8" FIRERATED DRYWALL NONE NO NONE ALLOY	UNDER FRONT PORCH											
3174 CONCRETE SEALANT 1x4 55/8" FIRERATED DRYWALL NONE NO NONE ALLOY ALLOY R RESISTANT GYPSUM BOARD CANNOT BE USED FOR WALLS IN SHOWER COMPARTMENTS OR IN AREAS OF HIGH HUMIDITY OR AREAS EXPOSED TO WATER PER ALLOY ALL	OVERED PATIO											
ASCHEDULE NOTES: R RESISTANT GYPSUM BOARD CANNOT BE USED FOR WALLS IN SHOWER COMPARTMENTS OR IN AREAS OF HIGH HUMIDITY OR AREAS EXPOSED TO WATER PER 3.7, R702.3.7.1. ALLOY AL	UD ROOM											
R RESISTANT GYPSUM BOARD CANNOT BE USED FOR WALLS IN SHOWER COMPARTMENTS OR IN AREAS OF HIGH HUMIDITY OR AREAS EXPOSED TO WATER PER ALLO ALLO ALLO ALLO ALLO ALLO ALLO ALLO DO DO The state of the state o	GE		ICONCRETE SEALA	NT 1)	x4	5/8" FIF	RERATED DI	RYWALL	NONE	INO	INONE	
ALLO ALLO ALLO ALLO ALLO ALLO ALLO ALLO	FINISH SCHEDULE NOTES											
ALLO ALLO ALLO DO		UM BOARD (CANNOT BE USED FOR W	'ALLS IN SHO'	WER CO	MPARTMEN	IS OR IN AF	REAS OF HI	GH HUMIDITY	UR AREAS EXPOSEI) IO WATER PER	
ALLO ALLO ALLO DO	R702.3.7, R702.3.7.1.											
ALLO ALLO DO												
ALLO DO												
DO												
												ALLO
												D
$\begin{array}{cccccccccccccccccccccccccccccccccccc$	A! C!!			. 21.7" .				מי מיי			وا عال	
	4-0	 	-5	2-1		+		o -∪			0-2	+
		-								·		

	I=	DOOR SCHEDULE		1==	
TAG	TYPE AND SIZE	MANUFACTURER	MATERIAL	REMARKS	QUANTITY
D01	DOOR EXTERIOR PIVOT 54x120				1
D02	DOOR EXTERIOR SWING 36x108	EURO-WALL VISTA TL IMPACT SYSTEM			2
D03	DOOR EXTERIOR SWING 28x108	EURO-WALL VISTA TL IMPACT SYSTEM			1
D04	DOOR EXTERIOR SLIDING 2P 96x120	EURO-WALL VISTA TL IMPACT SYSTEM			1
D05	DOOR EXTERIOR SLIDING 2P 98x120	EURO-WALL VISTA TL IMPACT SYSTEM			1
D06	DOOR EXTERIOR OVERHEAD 120x84	CLOPAY			2
D07	DOOR EXTERIOR OVERHEAD 72x84	CLOPAY			1
D08	DOOR INTERIOR SWING 30x96				1
D09	DOOR INTERIOR SWING 32x96				2
D10	DOOR INTERIOR SWING 24X96				1
D11	DOOR INTERIOR SWING 28x96				5
D12	DOOR INTERIOR SWING 24X96 PAIR				1
D14	DOOR INTERIOR POCKET 32x96				8
D15	DOOR INTERIOR POCKET 30x96				1
D16	DOOR INTERIOR SWING 36x96				8

WARE CONTRACTOR TO REVIEW KEYING WITH OWNER PRIOR TO PLACING HARDWARE ORDER. RIOR DOORS WITH GLASS TO HAVE IMPACT RESISTANT GLAZING

IDE RATED & NON-RATED ACCESS DOORS AT GROUND FLOOR AND AS CALLED OUT ON FLOOR PLANS. ALL TOR DOORS TO HAVE 30 MIN. RATING AND BE SELF CLOSING.

RIOR DOORS TO HAVE STANDARD INTERIOR FINISH AS SELECTED BY OWNER AND DESIGNER. EXTERIOR TO

GE DOOR GLAZED OPENING PROTECTION FOR WINDBORNE DEBRIES SHALL MEET THE REQUIRMENTS OF AN AVED IMPACT DECISTING STANDARD OR ANGLIDASMA 115. THE DERMANENT STICKER INDICATING COMPLIANCE

		SCHEDULE OF ALLOWANCES	
ALLOW	\$30,000.00	BATHROOM CASEWORK AND CABINETS	
ALLOW	\$75,000.00	KITCHEN CASEWORK AND CABINETS	
ALLOW	\$25,000.00	OWNERS CLOSET CASEWORK AND CABINETS	
ALLOW	\$50,000.00	CABINETS AND BUILT INS	
ALLOW	\$70,000.00	COUNTERTOPS	
ALLOW	\$40,000.00	PLUMBING FIXTURES	
ALLOW	\$25,000.00	PENDENT AND DECORATIVE LIGHT FIXTURES	
ALLOW	\$85,000.00	SUPPLY AND INSTALL APPLIANCES	
ALLOW	\$8,000.00	MIRRORS AND BATH ACCESSORIES	
ALLOW	\$13,500.00	SHOWER DOORS	
ALLOW	\$60,000.00	WINDOW TREATMENTS	
ALLOW	\$45,000.00	SMART HOME AUTOMATION, VIDEO AND AUDIO SYSTEMS	
ALLOW	\$12,500.00	LOW VOLTAGE DECK AND STEP LIGHTING	
ALLOW	\$14.00	PER S.F. FOR TILE MATERIAL	
ALLOW	\$10.00	PER S.F. FOR HARDWOOD FLOORING MATERIAL	
ALLOW	\$18,000.00	FOR FIREPLACE INSTALL AND TILE SURROUND	
ALLOW	ALLOW	GENERAC BACKUP GENERATOR	
ALLOW	\$40.00	PRE SQUARE YARD CARPET AND PADDING	
ALLOW	\$18,500.00	INTERIOR AND ENTRY DOOR HARDWARE	
ALLOW	\$95,000.00	LANDSCAPING AND IRRIGATION	_
	1,752,70000		

TITY	TAG	TYPE AND SIZE	MANUFACTURER	MATERIAL	REMARKS	QUANTI
	?					3
	Α	WINDOW CASEMENT FIXED 40x120	EURO-WALL VISTA TL IMPACT SYSTEM			3
	В	WINDOW CASEMENT FIXED 70x43	EURO-WALL VISTA TL IMPACT SYSTEM			2
	С	WINDOW CASEMENT 36x84	EURO-WALL VISTA TL IMPACT SYSTEM			2
	D	WINDOW CASEMENT FIXED 214X120	EURO-WALL VISTA TL IMPACT SYSTEM			1
	E	WINDOW CASEMENT FIXED 48x43	EURO-WALL VISTA TL IMPACT SYSTEM			3
	F	WINDOW CASEMENT FIXED 214x43	EURO-WALL VISTA TL IMPACT SYSTEM			1
	G	WINDOW CASEMENT FIXED 70x120	EURO-WALL VISTA TL IMPACT SYSTEM			2
	Н	WINDOW CASEMENT TRANSOM 39x24	EURO-WALL VISTA TL IMPACT SYSTEM			1
	I	WINDOW CASEMENT FIXED 200.9x132	EURO-WALL VISTA TL IMPACT SYSTEM			1
	J	WINDOW CASEMENT FIXED 40x24	EURO-WALL VISTA TL IMPACT SYSTEM			1
	K	WINDOW CASEMENT FIXED 36x24	EURO-WALL VISTA TL IMPACT SYSTEM			5
	L	WINDOW CASEMENT 32x72	EURO-WALL VISTA TL IMPACT SYSTEM			3
	M	WINDOW CASEMENT 24x72	EURO-WALL VISTA TL IMPACT SYSTEM			1
	N	WINDOW CASEMENT 40x96	EURO-WALL VISTA TL IMPACT SYSTEM			6
CT	0	WINDOW CASEMENT FIXED 40x36	EURO-WALL VISTA TL IMPACT SYSTEM			2
	Р	WINDOW CASEMENT FIXED 40x90	EURO-WALL VISTA TL IMPACT SYSTEM			3
2	Q	WINDOW CASEMENT 40x108	EURO-WALL VISTA TL IMPACT SYSTEM			4
	R	WINDOW CASEMENT 96x108	EURO-WALL VISTA TL IMPACT SYSTEM			1
	S	WINDOW CASEMENT FIXED 170x108	EURO-WALL VISTA TL IMPACT SYSTEM			2
	Т	WINDOW CASEMENT FIXED 67x108	EURO-WALL VISTA TL IMPACT SYSTEM			2
	U	WINDOW CASEMENT FIXED 135.5x132	EURO-WALL VISTA TL IMPACT SYSTEM			1
	1.	ALL WINDOWS SHALL HAVE A MINIMUM D	OUBLE PANE AND LOW-E GLAZING AND M	EET IMPACT	PROTECTION	•
			ET 2021 IBC CODE REQUIREMENTS FOR (DR			
			S IN ACCORDANCE WITH 2021 IRC SECTIOI	N R308.4 ALL	WINDOWS TO	HAVE IM
	DEGIG	STANT OLAZINO				

IMPACT RESISTANT GLAZING.

WINDOW SCHEDULE

ALL WINDOW HEIGHTS ARE NOMINAL. VERIFY ROUGH OPENING DIMENSIONS WITH WINDOW MANUFACTURER BEFORE PLACING WINDOW ORDER. NOTIFY ARCHITECT OF ANY DISCREPANCIES. ALL WINDOWS BY EURO-WALL VISTA TL IMPACT SERIES, PROVIDE PRICE ALTERNATIVE FOR MARVIN SIGNATURE ULTIMATE

OR ARCHITECT APPROVED EQUIV. OPERABLE WINDOWS TO HAVE SCREENS AS DETERMINED BY OWNER. ALL BEDROOMS (AND ROOMS WITH CLOSETS) TO HAVE WINDOWS THAT MEET THE CLEAR OPENING REQUIREMENT FOR EGRESS. WINDOW COLOR TO BE "BRONZE". INTERIOR FINISH TO BE WHITE OAK (EURO-WALL). FINISH HARDWARE TO BE


SELECTED BY OWNER. ALL GANGS OF WINDOWS TO BE FACTORY JOINED

ALL WINDOW AND DOORS TO HAVE IMPACT RESISTANT GLAZING AND MEET TEST CRITERIA IN IRC 308.3.1

COORDINATE ALL ROUGH OPENING DIMENSIONS TO ENSURE PROPER CONSTRUCTION

VERIFY ALL WINDOW AND DOOR STYLES AND ALIGNMENTS. PROVIDE ARCHITECT WITH SHOP DRAWINGS FOR FINAL APPROVAL PRIOR TO PLACING ORDER.

FIELD VERIFY DIMENSIONS AND ROUGH OPENINGS AS WELL AS WINDOW STYLE, DOOR SWINGS, AND WINDOW SWINGS PRIOR TO PLACING ORDER.

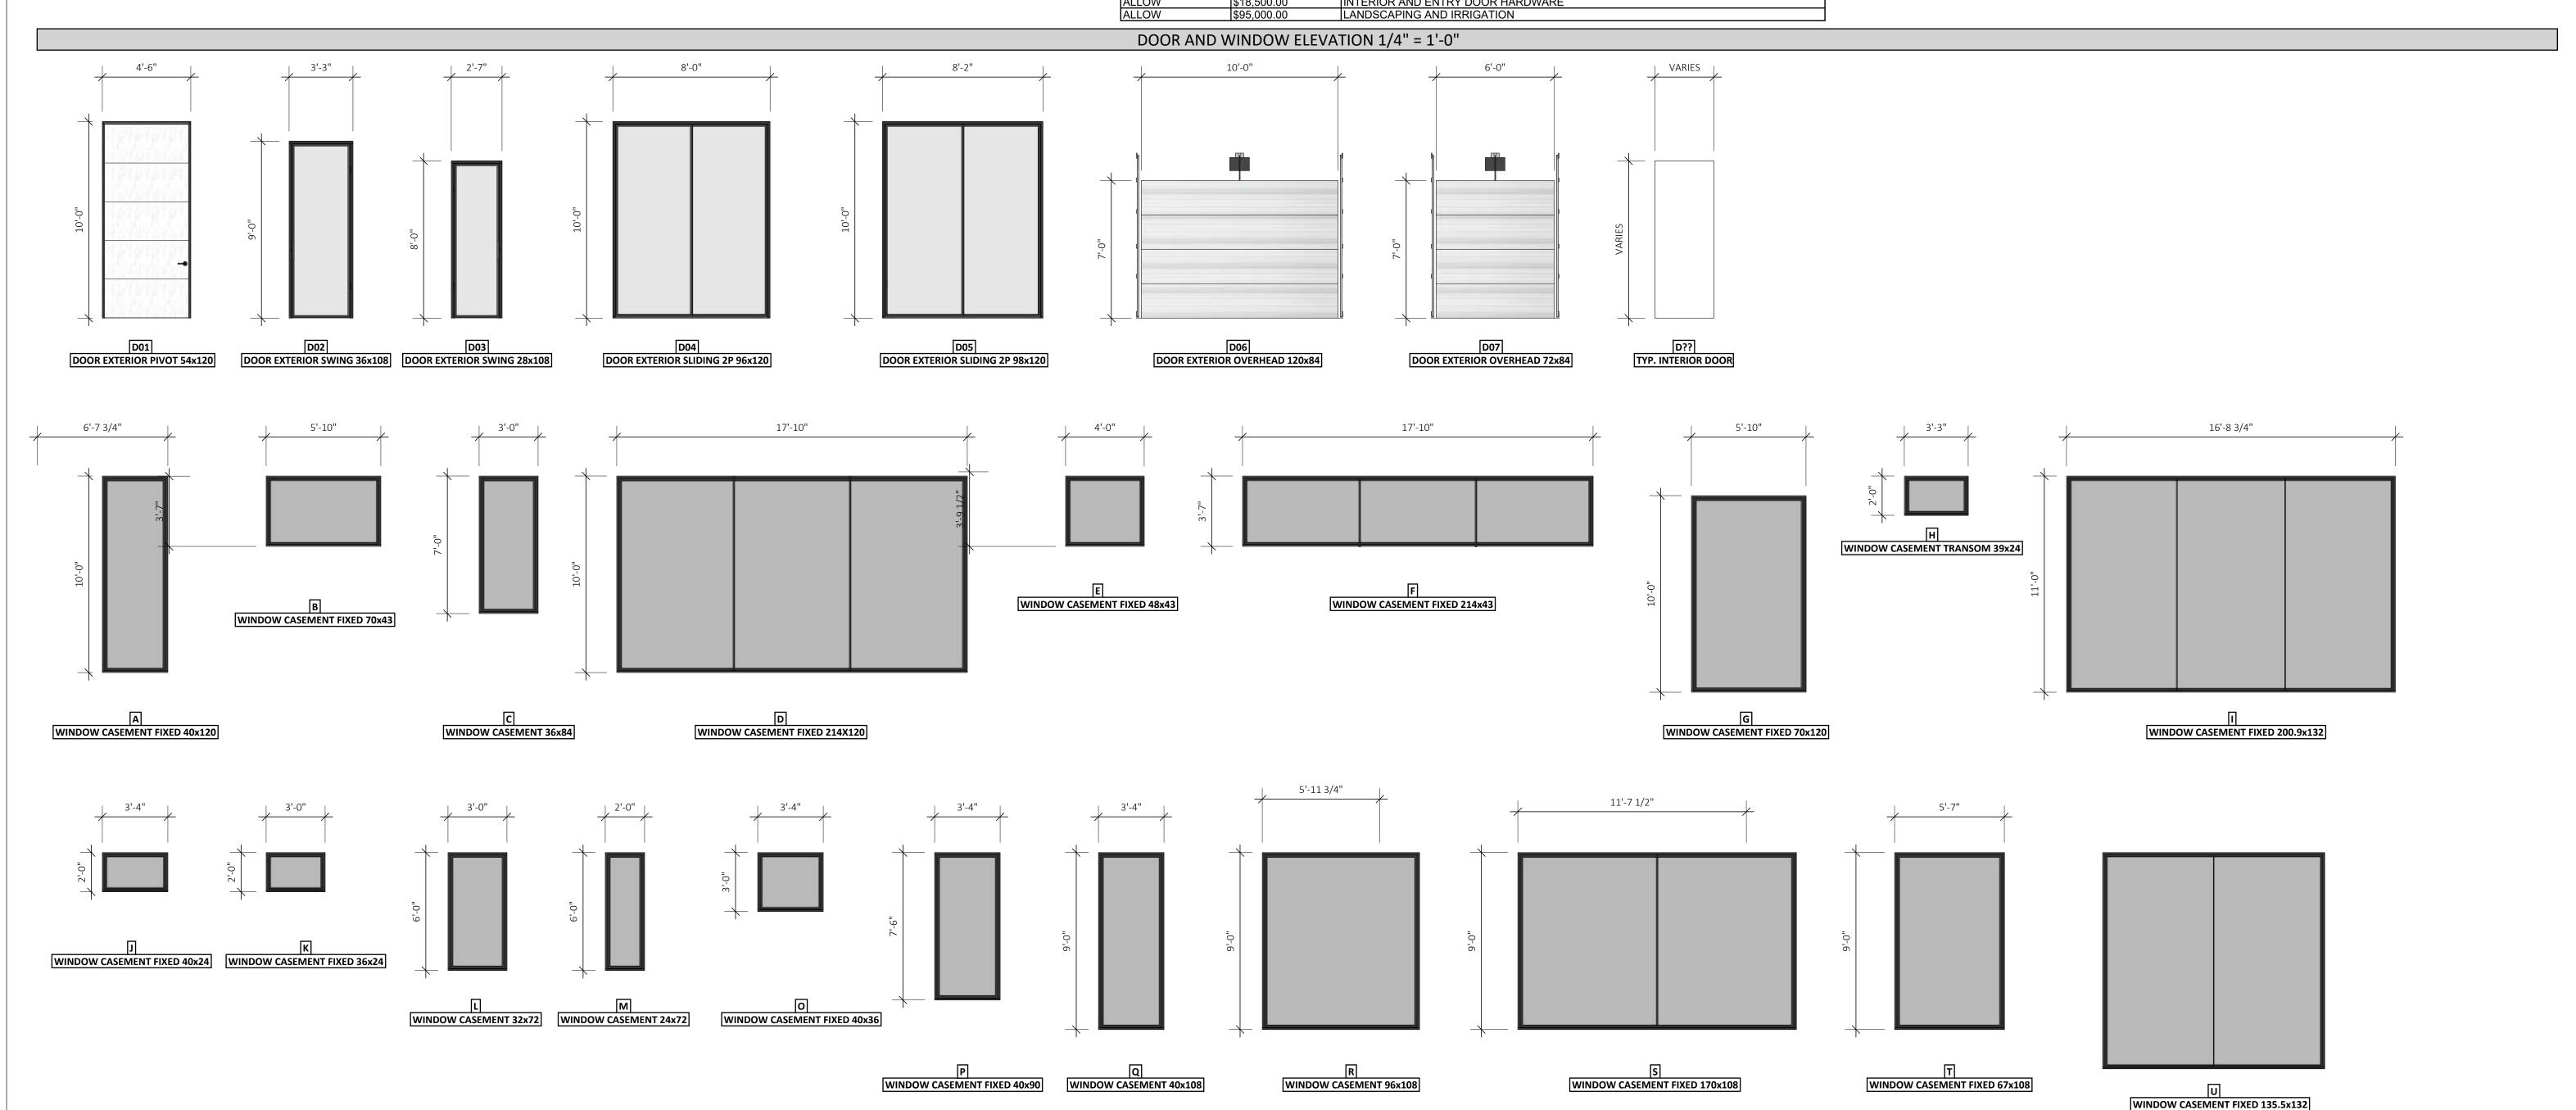

COPYRIGHT 2024 ALL RIGHTS COPYRIGHT 2024 ALL RIGHTS
RESERVED
IT IS A VIOLATION OF LAW FOR ANY
PERSON, UNLESS ACTING UNDER THE
DIRECTION OF DLB CUSTOM HOME
DESIGN, TO ALTER THIS DOCUMENT.
PRINTED OR ELECTRONIC DRAWINGS
AND DOCUMENTATION MAY NOT BE
REPRODUCED IN ANY FORM WITHOUT
WRITTEN PERMISSION. THIS DRAWING WAS PREPARED AT THE SCALE INDICATED.
INACCURACIES IN THE STATED SCALE MAY BE INTRODUCED WHEN DRAWINGS ARE REPRODUCED BY ANY MEANS. USE THE GRAPHIC SCALE BAR TO DETERMINE THE ACTUAL SCALE.


JOB NO.: DESIGN BY: DRAWN BY:

DATE: 6/18/2025 SCALE: 1/4" = 1'-0" U.N.O.


SCHEDULES AND DETAILS


SHEET NO.

A-2.4

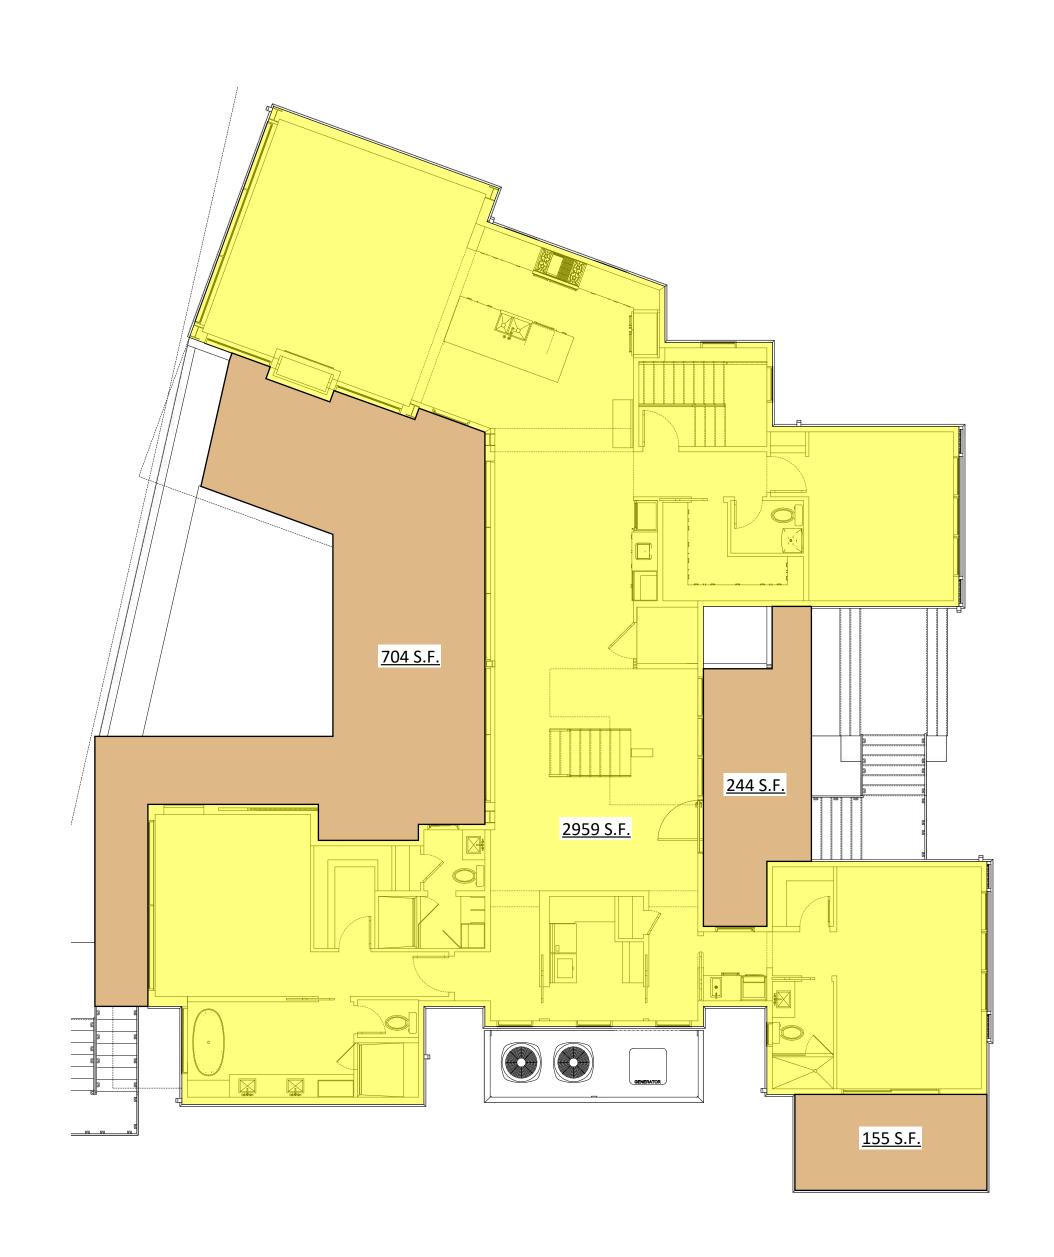



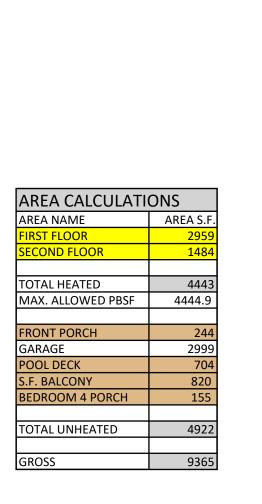

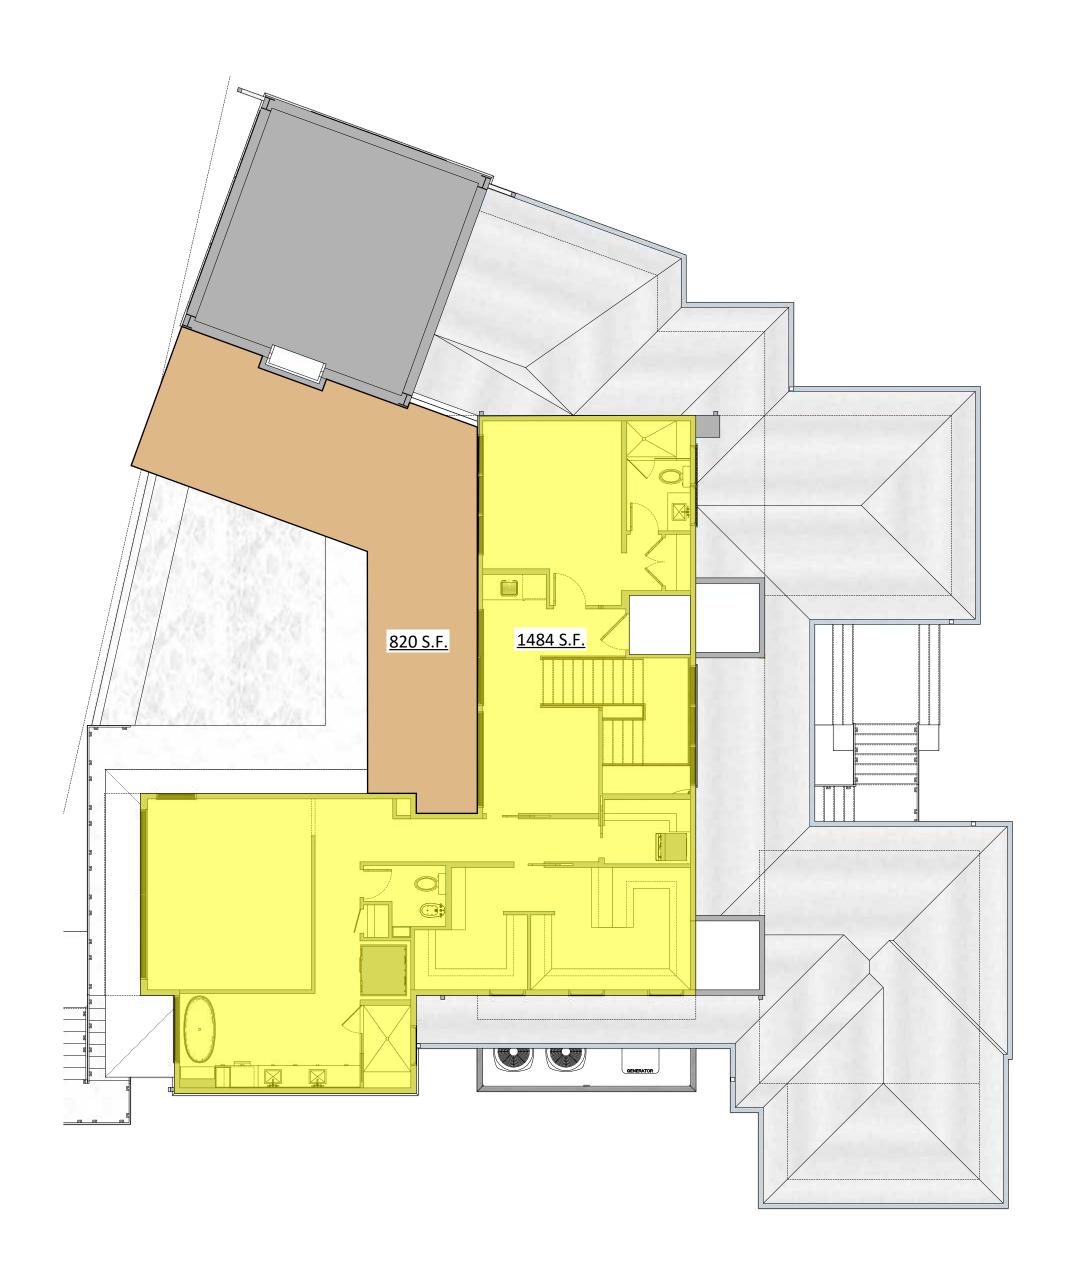


2 SECOND FLOOR PLAN
SCALE 1/8" = 1'-0"

	<u> </u>						
DATE	07/19/24	01/15/25	01/29/25	03/20/25	06/04/25	7/3/2025	
NO. REVISION DESCRIPTION	CONCEPTUAL DESIGN	DRB FINAL SUBMITTAL	SET	PERMIT REVIEW SET	PERMIT COMMENTS	PERMIT COMMENTS	
o. REVI	CON	2 DRB	BID SET				
	SOUTH	DLB	Destray Re	Charleston, SC	EG)	OSPEN ARCHIT	
	SOUTH	I deliment	Busillo	Charleston, SC	(EG)	CARED ARCH	
RE IT I PE DIFF ARE WE THEN SC AN SC	PYRIC SERV S A VI RSON RECTION SIGN, INTED D DOO PROD RITTEN IS DR. ACCUR ACCUR ACCUR ALE M AUIN ALE B TUAL	ED OLAT , UNL ON OF TO A O OR E CUME UCEE N PER AWING LLE IN RACIE IAY BI GS AF ANS.	CION CESS AS TOUR TOUR TOUR TOUR TOUR TOUR TOUR TOUR	OF LAVACTINA CUSTANDIAN THIS FROMITION IN THE STANDIAN THE STANDIAN THE GROUP THE GROU	W FOI G UNI FOM H DOCU C DR IAY N DRM V FPARE TATE CED DUCEI RAPH	DER THOME JMEN AWIN OT BE VITHO ED AT D WHEN D BY HIC	THE T. GS E DUT
ONI NOISEGEMON MOTOLING	DED COST OM TOME DESIGN. THO	PHONE: 843-303-2979 EMAIL: DLBCUSTOMHOMEDESIGN@GMAIL.COM	WWW.DLBCUSTOMHOMEDESIGN.COM	DALY AND SAWYER	CONSTRUCTION CO	MT. PLEASANT, SC 29464	(843) 884-7195
BARKOWITZ BESIDENCE	DAIMOVIIE INCOIDEINOE	ABCHITECTIIBAI DI ANG		SZUS MAKSHALL BLVD.	SOLLIVANS ISLAND	CHARLES I ON COON I Y, SC	LOI I, BLOCK 16,
	OB I		BY.				111 DLB
	RAV						DLB
	ATE				6/18	2/20	125

BARKO	ARCHIT	S	CHAR	
JOB	NO.:		2	2411
DES			DLB	
DRA			DLB	
DAT	E:	6/	18/2	2025

DRA	AWN	BY:	С
DA	ГЕ:		6/18/20
SCA	ALE:	1/4" =	1'-0" U.N
SHEET TITLE:		GRAPHIC AREAS	

SHEET NO. A-2.4

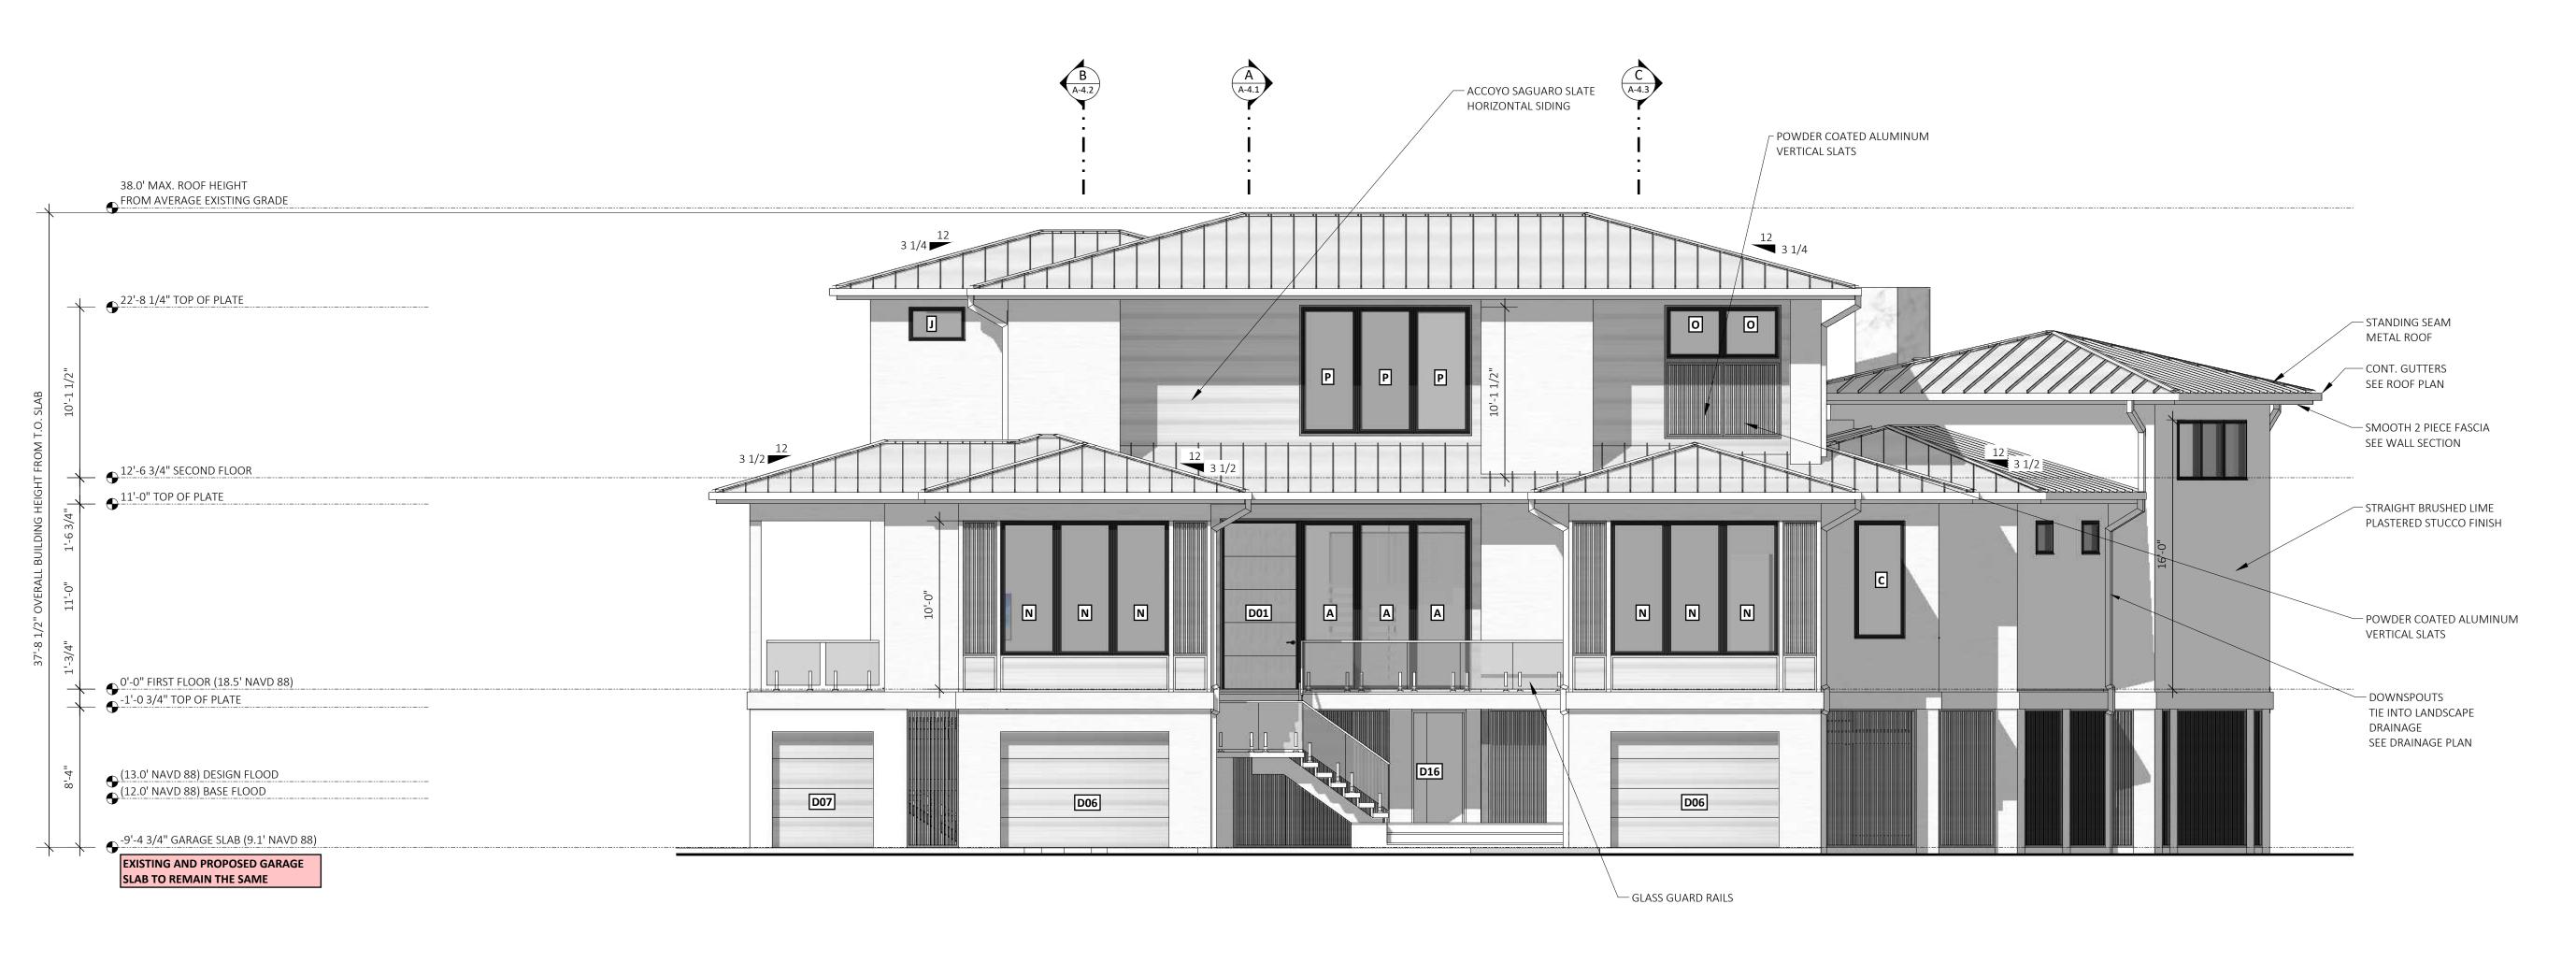

1 FRONT ELEVATION SCALE 3/16" = 1'-0"

COPYRIGHT 2024 ALL RIGHTS COPYRIGHT 2024 ALL RIGHTS
RESERVED
IT IS A VIOLATION OF LAW FOR ANY
PERSON, UNLESS ACTING UNDER THE
DIRECTION OF DLB CUSTOM HOME
DESIGN, TO ALTER THIS DOCUMENT.
PRINTED OR ELECTRONIC DRAWINGS
AND DOCUMENTATION MAY NOT BE
REPRODUCED IN ANY FORM WITHOUT
WRITTEN PERMISSION. THIS DRAWING WAS PREPARED AT THE SCALE INDICATED. INACCURACIES IN THE STATED SCALE MAY BE INTRODUCED WHEN DRAWINGS ARE REPRODUCED BY ANY MEANS. USE THE GRAPHIC SCALE BAR TO DETERMINE THE ACTUAL SCALE.

BARKOWITZ RESIDENCE
ARCHITECTURAL PLANS
3203 MARSHALL BLVD.
SULLIVANS ISLAND
CHARLESTON COUNTY, SC
LOT 1, BLOCK 16,

JOB NO.: DESIGN BY: DRAWN BY:

DATE: 6/18/2025 SCALE: 1/4" = 1'-0" U.N.O.

FRONT ELEVATION

SHEET NO.



COPYRIGHT 2024 ALL RIGHTS
RESERVED
IT IS A VIOLATION OF LAW FOR ANY
PERSON, UNLESS ACTING UNDER THE
DIRECTION OF DLB CUSTOM HOME
DESIGN, TO ALTER THIS DOCUMENT.
PRINTED OR ELECTRONIC DRAWINGS
AND DOCUMENTATION MAY NOT BE
REPRODUCED IN ANY FORM WITHOUT
WRITTEN PERMISSION. THIS DRAWING WAS PREPARED AT THE SCALE INDICATED.
INACCURACIES IN THE STATED SCALE MAY BE INTRODUCED WHEN DRAWINGS ARE REPRODUCED BY ANY MEANS. USE THE GRAPHIC SCALE BAR TO DETERMINE THE ACTUAL SCALE.

BARKOWITZ RESIDENCE
ARCHITECTURAL PLANS
3203 MARSHALL BLVD.
SULLIVANS ISLAND
CHARLESTON COUNTY, SC
LOT 1, BLOCK 16,

JOB NO.: DESIGN BY:

DRAWN BY: 6/18/2025 DATE:

SCALE: 1/4" = 1'-0" U.N.O.

FRONT ELEVATION IN CONTEXT

SHEET NO.

A-3.1.1



1 BACK ELEVATION SCALE 3/16" = 1'-0"

COPYRIGHT 2024 ALL RIGHTS

COPYRIGHT 2024 ALL RIGHTS
RESERVED
IT IS A VIOLATION OF LAW FOR ANY
PERSON, UNLESS ACTING UNDER THE
DIRECTION OF DLB CUSTOM HOME
DESIGN, TO ALTER THIS DOCUMENT.
PRINTED OR ELECTRONIC DRAWINGS
AND DOCUMENTATION MAY NOT BE
REPRODUCED IN ANY FORM WITHOUT
WRITTEN PERMISSION.

THIS DRAWING WAS PREPARED AT THE SCALE INDICATED. INACCURACIES IN THE STATED SCALE MAY BE INTRODUCED WHEN DRAWINGS ARE REPRODUCED BY ANY MEANS. USE THE GRAPHIC SCALE BAR TO DETERMINE THE ACTUAL SCALE.


BARKOWITZ RESIDENCE
ARCHITECTURAL PLANS
3203 MARSHALL BLVD.
SULLIVANS ISLAND
CHARLESTON COUNTY, SC
LOT 1, BLOCK 16,

JOB NO.: DESIGN BY: DRAWN BY:

DATE: 6/18/2025 SCALE: 1/4" = 1'-0" U.N.O.

BACK ELEVATION

SHEET NO.

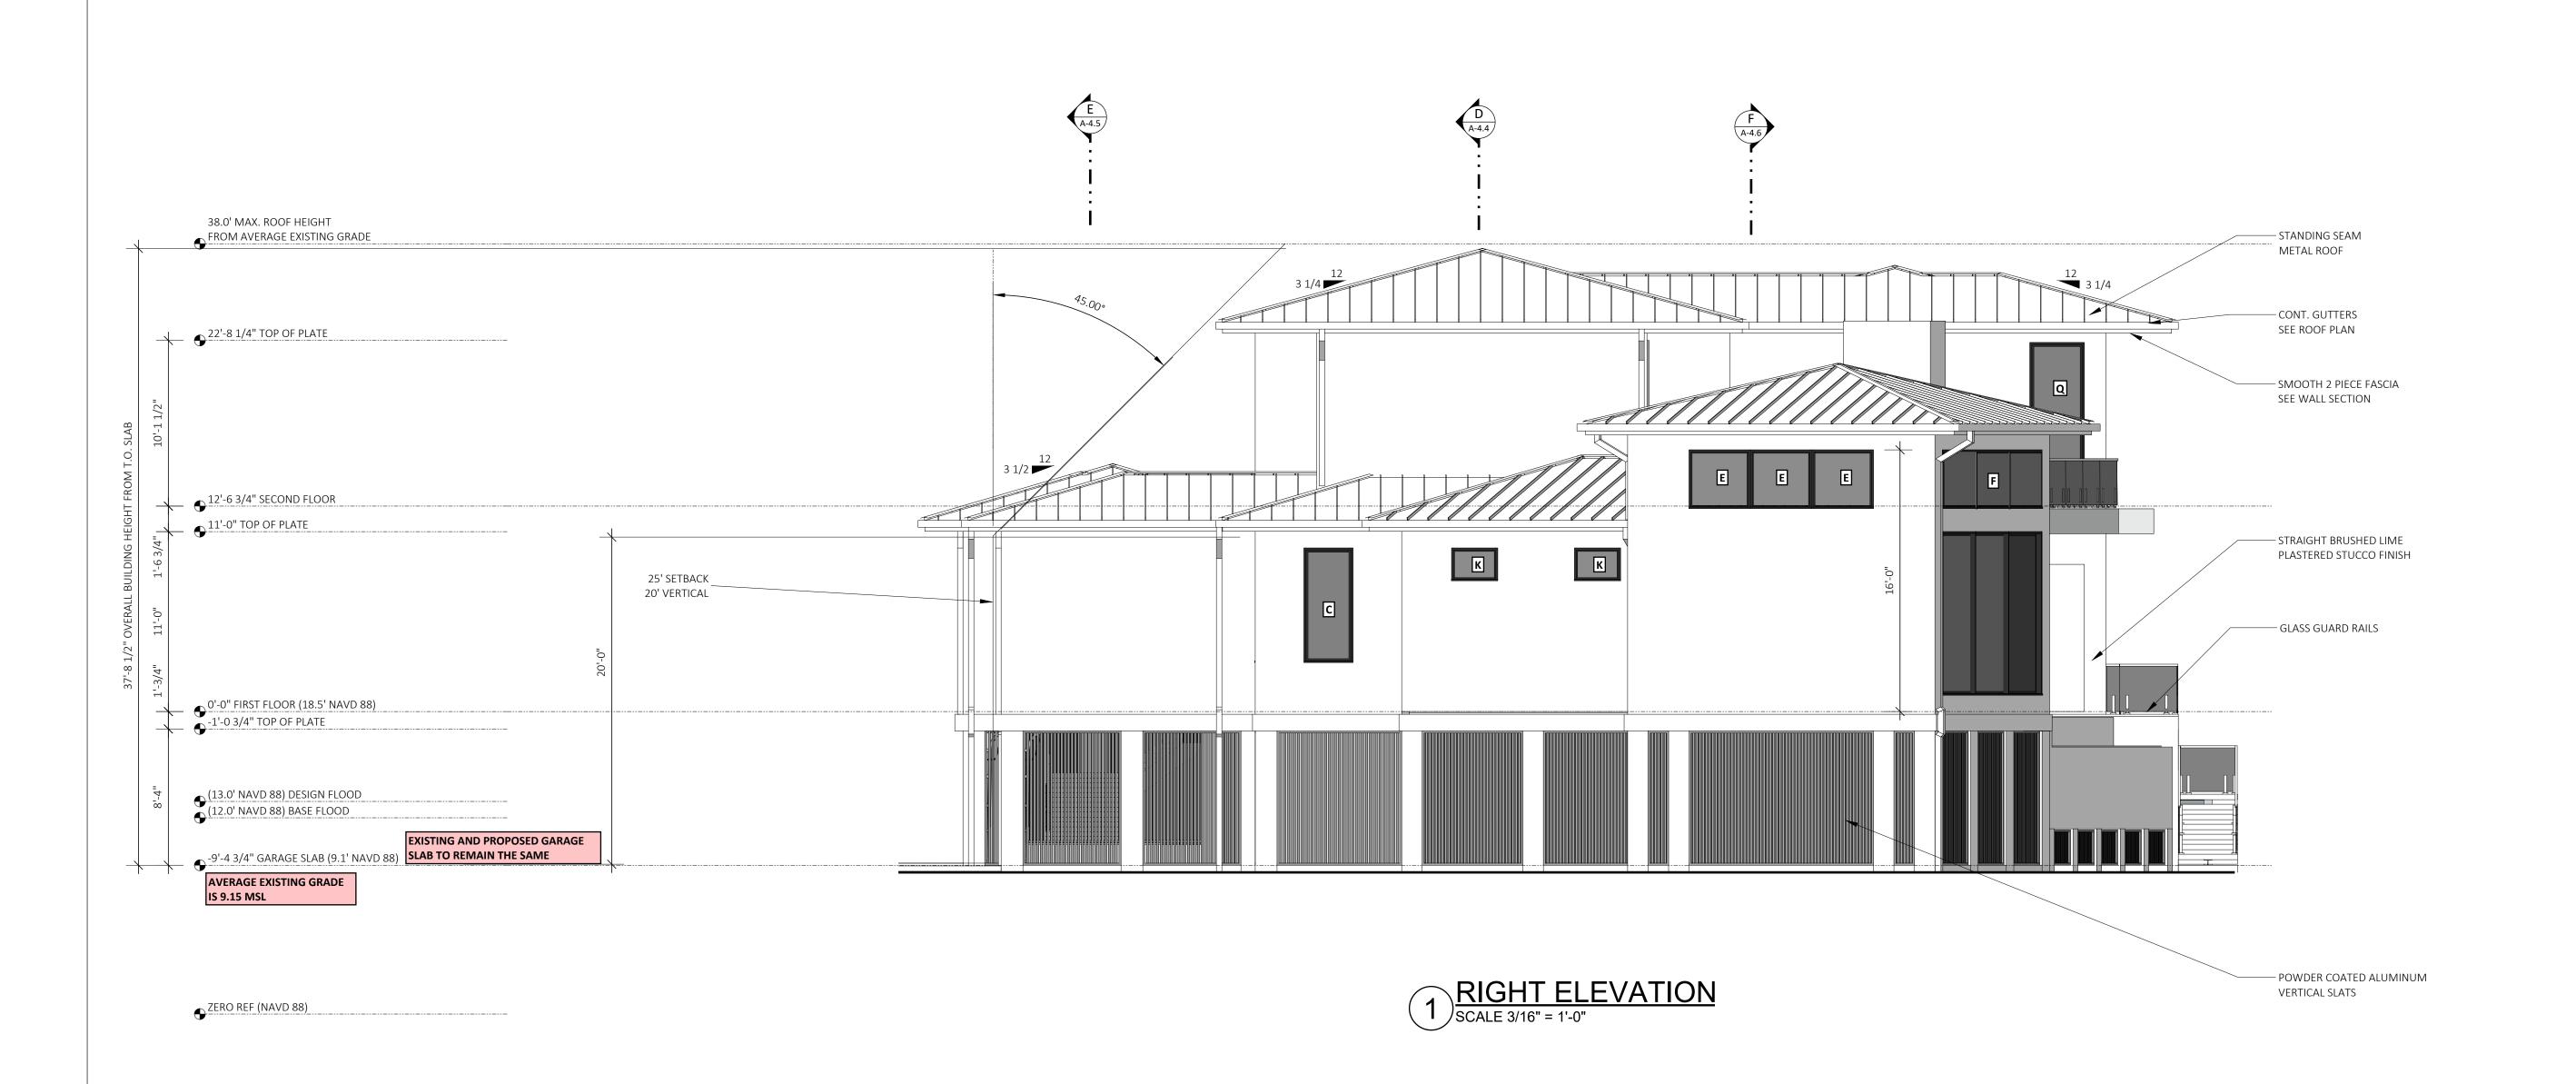

 MO.
 REVISION DESCRIPTION
 DATE

 1
 CONCEPTUAL DESIGN
 07/19/24

 2
 DRB FINAL SUBMITTAL
 01/15/25

 3
 BID SET
 01/29/25

 4
 PERMIT REVIEW SET
 03/20/25

 5
 PERMIT COMMENTS
 06/04/25

 6
 PERMIT COMMENTS
 7/3/2025

DLB DLB ASSER, Inc.
Charleston, SC 101084

Busillo Busillo AR. 9183

COPYRIGHT 2024 ALL RIGHTS
RESERVED
IT IS A VIOLATION OF LAW FOR ANY
PERSON, UNLESS ACTING UNDER THE
DIRECTION OF DLB CUSTOM HOME
DESIGN, TO ALTER THIS DOCUMENT.
PRINTED OR ELECTRONIC DRAWINGS
AND DOCUMENTATION MAY NOT BE
REPRODUCED IN ANY FORM WITHOUT
WRITTEN PERMISSION.
THIS DRAWING WAS PREPARED AT
THE SCALE INDICATED.
INACCURACIES IN THE STATED
SCALE MAY BE INTRODUCED WHEN
DRAWINGS ARE REPRODUCED BY
ANY MEANS. USE THE GRAPHIC
SCALE BAR TO DETERMINE THE
ACTUAL SCALE.

DLB CUSTOM HOME DESIGN, INC
PHONE: 843-303-2979
AIL: DLBCUSTOMHOMEDESIGN@GMAIL.COM
WWW.DLBCUSTOMHOMEDESIGN.COM

DALY AND SAWYER

CONSTRUCTION CO

855 COLEMAN BLVD

MT. PLEASANT, SC 29464

CHITECTURAL PLANS
3203 MARSHALL BLVD.
SULLIVANS ISLAND
CHARLESTON COUNTY, SC

JOB NO.: 2411

DESIGN BY: DLE

DRAWN BY: DLE

DATE: 6/18/2025

SCALE: 1/4" = 1'-0" U.N.O.

SHEET TITLE:
RIGHT ELEVATION

SHEET NO.



COPYRIGHT 2024 ALL RIGHTS COPYRIGHT 2024 ALL RIGHTS
RESERVED
IT IS A VIOLATION OF LAW FOR ANY
PERSON, UNLESS ACTING UNDER THE
DIRECTION OF DLB CUSTOM HOME
DESIGN, TO ALTER THIS DOCUMENT.
PRINTED OR ELECTRONIC DRAWINGS
AND DOCUMENTATION MAY NOT BE
REPRODUCED IN ANY FORM WITHOUT
WRITTEN PERMISSION. THIS DRAWING WAS PREPARED AT THE SCALE INDICATED. INACCURACIES IN THE STATED SCALE MAY BE INTRODUCED WHEN DRAWINGS ARE REPRODUCED BY ANY MEANS. USE THE GRAPHIC SCALE BAR TO DETERMINE THE ACTUAL SCALE.

BARKOWITZ RESIDENCE
ARCHITECTURAL PLANS
3203 MARSHALL BLVD.
SULLIVANS ISLAND
CHARLESTON COUNTY, SC
LOT 1, BLOCK 16,

JOB NO.: DESIGN BY: DRAWN BY: DATE: 6/18/2025 SCALE: 1/4" = 1'-0" U.N.O.

ELEVATION

SHEET NO.





 SOUTH
 NO. REVISION DESCRIPTION
 DATE

 Damign L. Mesting Busillo
 Charleston, SC AR. 9183
 DLB
 2
 DRB FINAL SUBMITTAL
 07/19/24

 Charleston, SC AR. 9183
 2
 DRB FINAL SUBMITTAL
 01/29/25

 AR. 9183
 4
 PERMIT COMMENTS
 06/04/25

 6
 PERMIT COMMENTS
 7/3/2025

COPYRIGHT 2024 ALL RIGHTS
RESERVED
IT IS A VIOLATION OF LAW FOR ANY
PERSON, UNLESS ACTING UNDER THE
DIRECTION OF DLB CUSTOM HOME
DESIGN, TO ALTER THIS DOCUMENT.
PRINTED OR ELECTRONIC DRAWINGS
AND DOCUMENTATION MAY NOT BE
REPRODUCED IN ANY FORM WITHOUT
WRITTEN PERMISSION.
THIS DRAWING WAS PREPARED AT

DLB CUSTOM HOME DESIGN, INC

PHONE: 843-303-2979

AIL: DLBCUSTOMHOMEDESIGN (BANK)

PHONE: 843-303-2979

AIL: DLBCUSTOMHOMEDESIGN (BANK)

PHONE: 843-303-2979

AIL: DLBCUSTOMHOMEDESIGN (BANK)

PARTINES AND SAWYER

CONSTRUCTION CO

855 COLEMAN BLVD

MT. PLEASANT, SC 29464

(843) 884-7195

ARCHITECTURAL PLANS
3203 MARSHALL BLVD.
SULLIVANS ISLAND
CHARLESTON COUNTY, SC
LOT 1, BLOCK 16,

JOB NO.: 2411

DESIGN BY: DLB

DRAWN BY: DLB

DATE: 6/18/2025 SCALE: 1/4" = 1'-0" U.N.O.

FRONT PERSPECTIVE

SHEET NO.





COPYRIGHT 2024 ALL RIGHTS
RESERVED
IT IS A VIOLATION OF LAW FOR ANY
PERSON, UNLESS ACTING UNDER THE
DIRECTION OF DLB CUSTOM HOME
DESIGN, TO ALTER THIS DOCUMENT.
PRINTED OR ELECTRONIC DRAWINGS
AND DOCUMENTATION MAY NOT BE
REPRODUCED IN ANY FORM WITHOUT
WRITTEN PERMISSION.
THIS DRAWING WAS PREPARED AT
THE SCALE INDICATED.
INACCULARCIES IN THE STATED

PRINTED OR ELECTRONIC DRAWINGS
AND DOCUMENTATION MAY NOT BE
REPRODUCED IN ANY FORM WITHOUT
WRITTEN PERMISSION.

THIS DRAWING WAS PREPARED AT
THE SCALE INDICATED.
INACCURACIES IN THE STATED
SCALE MAY BE INTRODUCED WHEN
DRAWINGS ARE REPRODUCED BY
ANY MEANS. USE THE GRAPHIC
SCALE BAR TO DETERMINE THE
ACTUAL SCALE.

PHONE: 843-303-2979
EMAIL: DLBCUSTOMHOMEDESIGN@GMAIL.CO
WWW.DLBCUSTOMHOMEDESIGN.COM

DALY AND SAWYER

CONSTRUCTION CO
855 COLEMAN BLVD
AT THE COLE

BARKOWITZ RESIDENCE
ARCHITECTURAL PLANS
3203 MARSHALL BLVD.
SULLIVANS ISLAND
CHARLESTON COUNTY, SC
LOT 1, BLOCK 16,

JOB NO.: 2411

DESIGN BY: DLB

DRAWN BY: DLB

DATE: 6/18/2025

SCALE: 1/4" = 1'-0" U.N.O.

FRONT PERSPECTIVE

SHEET NO.





 SOUTH
 NO. REVISION DESCRIPTION
 DATE

 Damign.
 1 CONCEPTUAL DESIGN
 07/19/24

 Damign.
 2 DRB FINAL SUBMITTAL
 01/15/25

 Busillo Meresign, Nac. Parallesten, SC AR.9183
 3 BID SET
 01/29/25

 AR.9183
 4 PERMIT REVIEW SET
 03/20/25

 6 PERMIT COMMENTS
 6 PERMIT COMMENTS
 7/3/2025

COPYRIGHT 2024 ALL RIGHTS
RESERVED
IT IS A VIOLATION OF LAW FOR ANY
PERSON, UNLESS ACTING UNDER THE
DIRECTION OF DLB CUSTOM HOME
DESIGN, TO ALTER THIS DOCUMENT.
PRINTED OR ELECTRONIC DRAWINGS
AND DOCUMENTATION MAY NOT BE
REPRODUCED IN ANY FORM WITHOUT
WRITTEN PERMISSION.
THIS DRAWING WAS PREPARED AT
THE SCALE INDICATED.
INACCURACIES IN THE STATED
SCALE MAY BE INTRODUCED WHEN
DRAWINGS ARE REPRODUCED BY
ANY MEANS. USE THE GRAPHIC
SCALE BAR TO DETERMINE THE
ACTUAL SCALE.

PHONE: 843-303-2979

PHONE: 843-303-2979

WWW.DLBCUSTOMHOMEDESIGN.COM

DALY AND SAWYER

CONSTRUCTION CO

855 COLEMAN BLVD

AT 25 COLEMAN BLVD

AT

ARCHITECTURAL PLANS
3203 MARSHALL BLVD.
SULLIVANS ISLAND
CHARLESTON COUNTY, SC

 JOB NO.:
 2411

 DESIGN BY:
 DLB

 DRAWN BY:
 DLB

 DATE:
 6/18/2025

SCALE: 1/4" = 1'-0" U.N.O.

BACK PERSPECTIVE

SHEET NO.





SOUTH CAN SOUTH

COPYRIGHT 2024 ALL RIGHTS
RESERVED
IT IS A VIOLATION OF LAW FOR ANY
PERSON, UNLESS ACTING UNDER THE
DIRECTION OF DLB CUSTOM HOME
DESIGN, TO ALTER THIS DOCUMENT.
PRINTED OR ELECTRONIC DRAWINGS
AND DOCUMENTATION MAY NOT BE
REPRODUCED IN ANY FORM WITHOUT
WRITTEN PERMISSION.
THIS DRAWING WAS PREPARED AT
THE SCALE INDICATED.
INACCURACIES IN THE STATED
SCALE MAY BE INTRODUCED WHEN
DRAWINGS ARE REPRODUCED BY
ANY MEANS. USE THE GRAPHIC
SCALE BAR TO DETERMINE THE
ACTUAL SCALE.

PHONE: 843-303-2979

WWW.DLBCUSTOMHOMEDESIGN.COM

DALY AND SAWYER

CONSTRUCTION CO

855 COLEMAN BLVD

MT PIFASANT SC 29464

ARCHITECTURAL PLANS
3203 MARSHALL BLVD.
SULLIVANS ISLAND
CHARLESTON COUNTY, SC

JOB NO.: 2411

DESIGN BY: DLB


DRAWN BY: DLB

DATE: 6/18/2025


SCALE: 1/4" = 1'-0" U.N.O.

BACK PERSPECTIVE


SHEET NO.

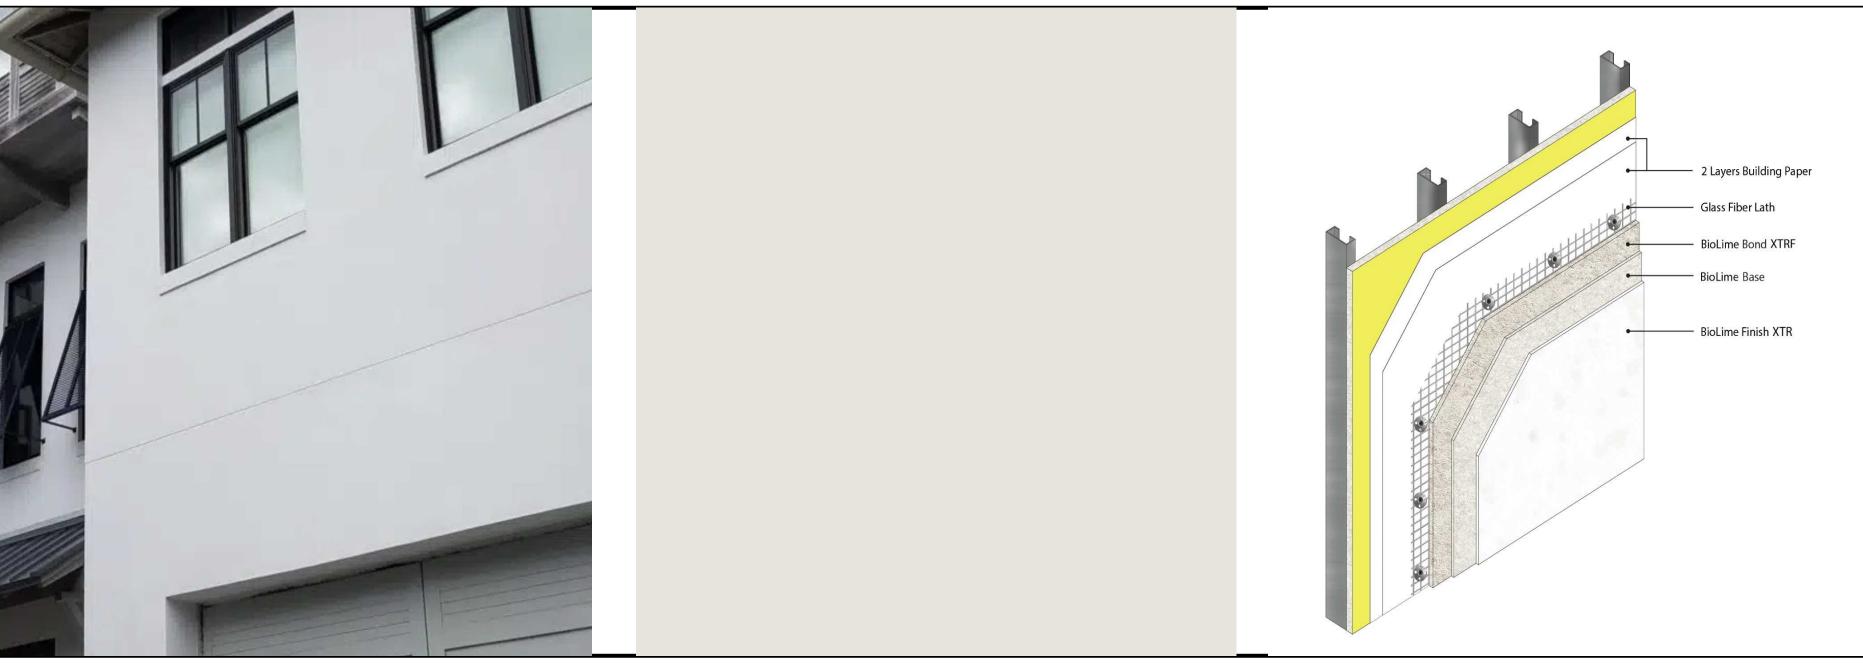

BIOLIME EXTERIOR LIME PLASTER FINISH, EXTRA FINE

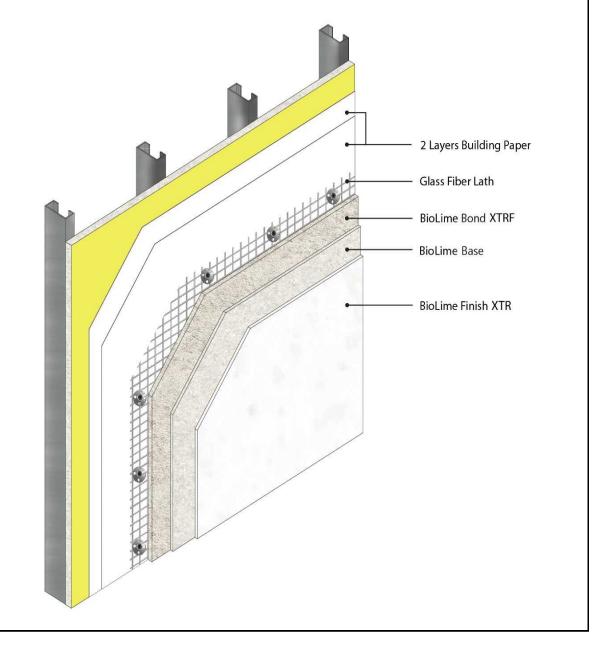


24 GAUGE MECHANICALLY SEAMED METAL ROOF

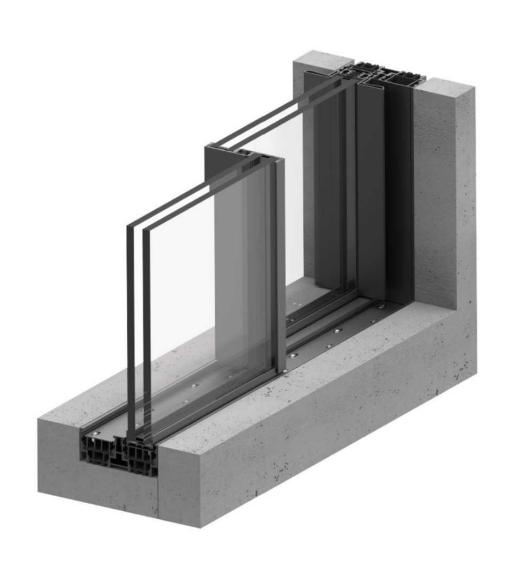

PANORAMAH AH38 EXTERIOR WINDOWS AND DOORS




VIEWRAIL GLASS RAILING SYSTEM WITH ASCEND TALON SPIGOTS

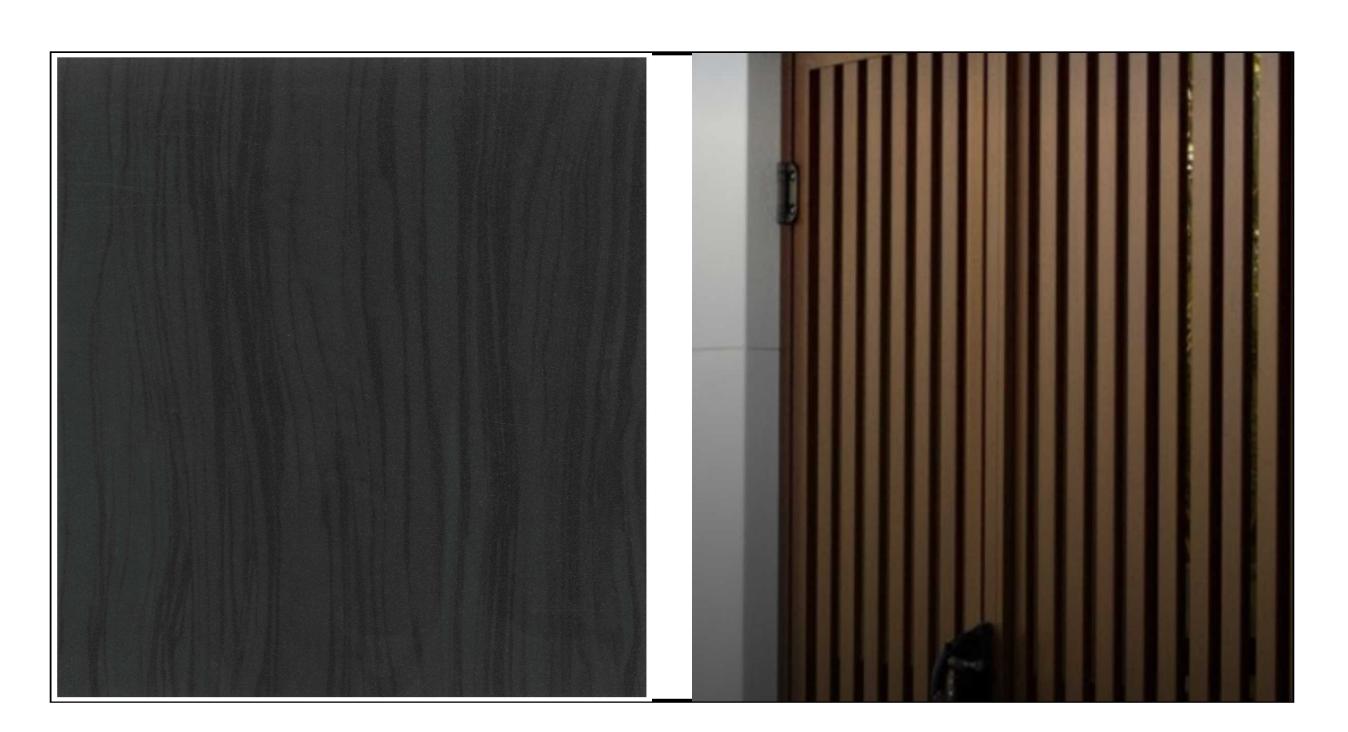


KNOTWOOD ALUMINUM SLATTED SCREEN SYSTEM IN CHARCOAL ASH WOOD GRAIN



ACCOYA SHIPLAP SIDING

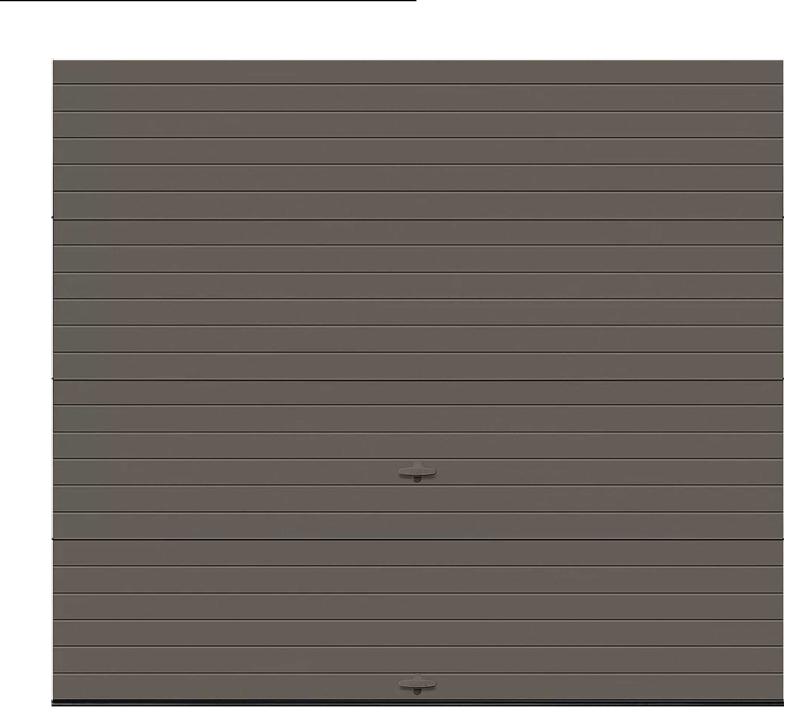

CLOPAY GARAGE DOOR

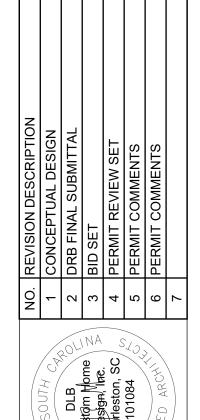




SCALE BAR TO DETERMINE THE ACTUAL SCALE.							
DLB CUSTOM HOME DESIGN, INC	PHONE: 843-303-2979 EMAIL: DLBCUSTOMHOMEDESIGN@GMAIL.COM WWW.DLBCUSTOMHOMEDESIGN.COM	DALY AND SAWYER	CONSTRUCTION CO	833 COLEMAN BLVD MT. PLEASANT, SC 29464	(843) 884-7195		

JOB NO.: 2411
DESIGN BY: DLB
DRAWN BY: DLB
DATE: 6/18/2025
SCALE: 1/4" = 1'-0" U.N.O.

SCA	ALE:	1/4" = 1'-0" (J.
SHEET TITLE:		EXTERIOR MATERIALS	

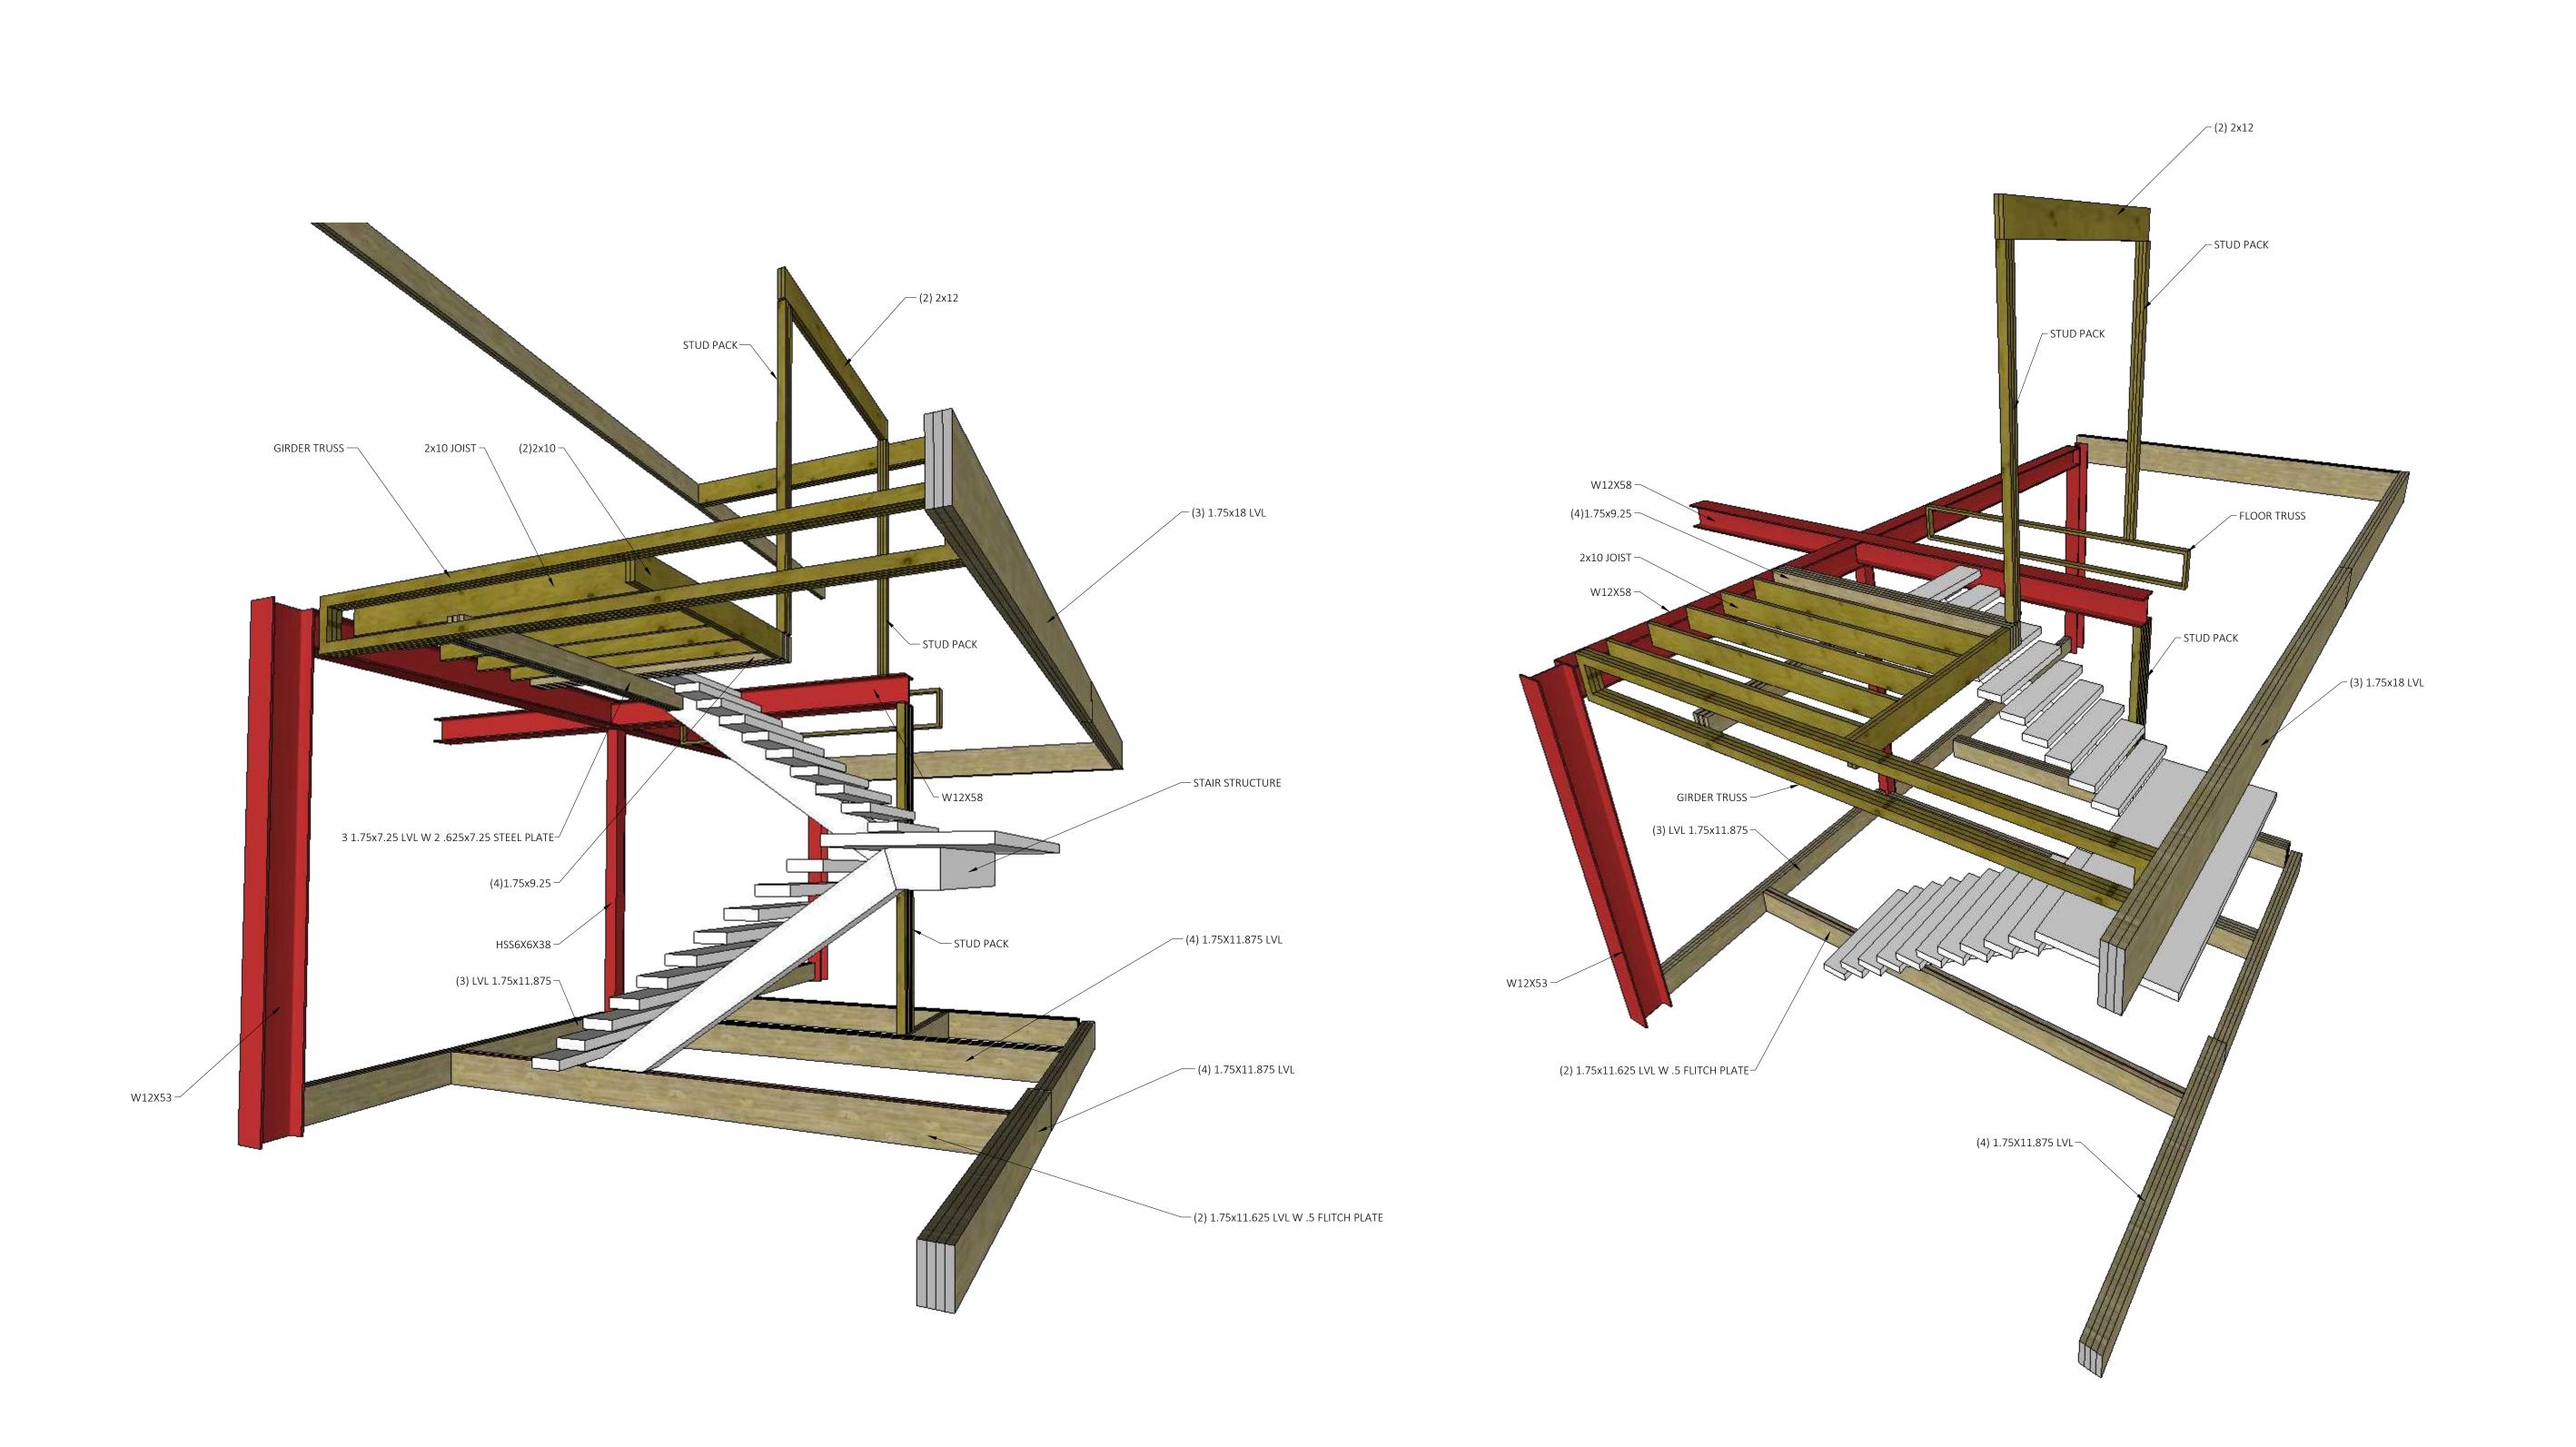

COPYRIGHT 2024 ALL RIGHTS
RESERVED
IT IS A VIOLATION OF LAW FOR ANY
PERSON, UNLESS ACTING UNDERT THE
DIRECTION OF DLB CUSTOM HOME
DESIGN, TO ALTER THIS DOCUMENT.
PRINTED OR ELECTRONIC DRAWINGS
AND DOCUMENTATION MAY NOT BE
REPRODUCED IN ANY FORM WITHOUT
WRITTEN PERMISSION.

WRITTEN PERMISSION.


THIS DRAWING WAS PREPARED AT THE SCALE INDICATED. INACCURACIES IN THE STATED SCALE MAY BE INTRODUCED WHEN DRAWINGS ARE REPRODUCED BY ANY MEANS. USE THE GRAPHIC SCALE BAR TO DETERMINE THE ACTUAL SCALE.

BARKOWITZ RESIDENCE
ARCHITECTURAL PLANS
3203 MARSHALL BLVD.
SULLIVANS ISLAND
CHARLESTON COUNTY, SC

JOB NO.: DESIGN BY: DRAWN BY:

6/18/2025 DATE: SCALE: 1/4" = 1'-0" U.N.O.

STAIR STRUCTURE PERSPECTIVES

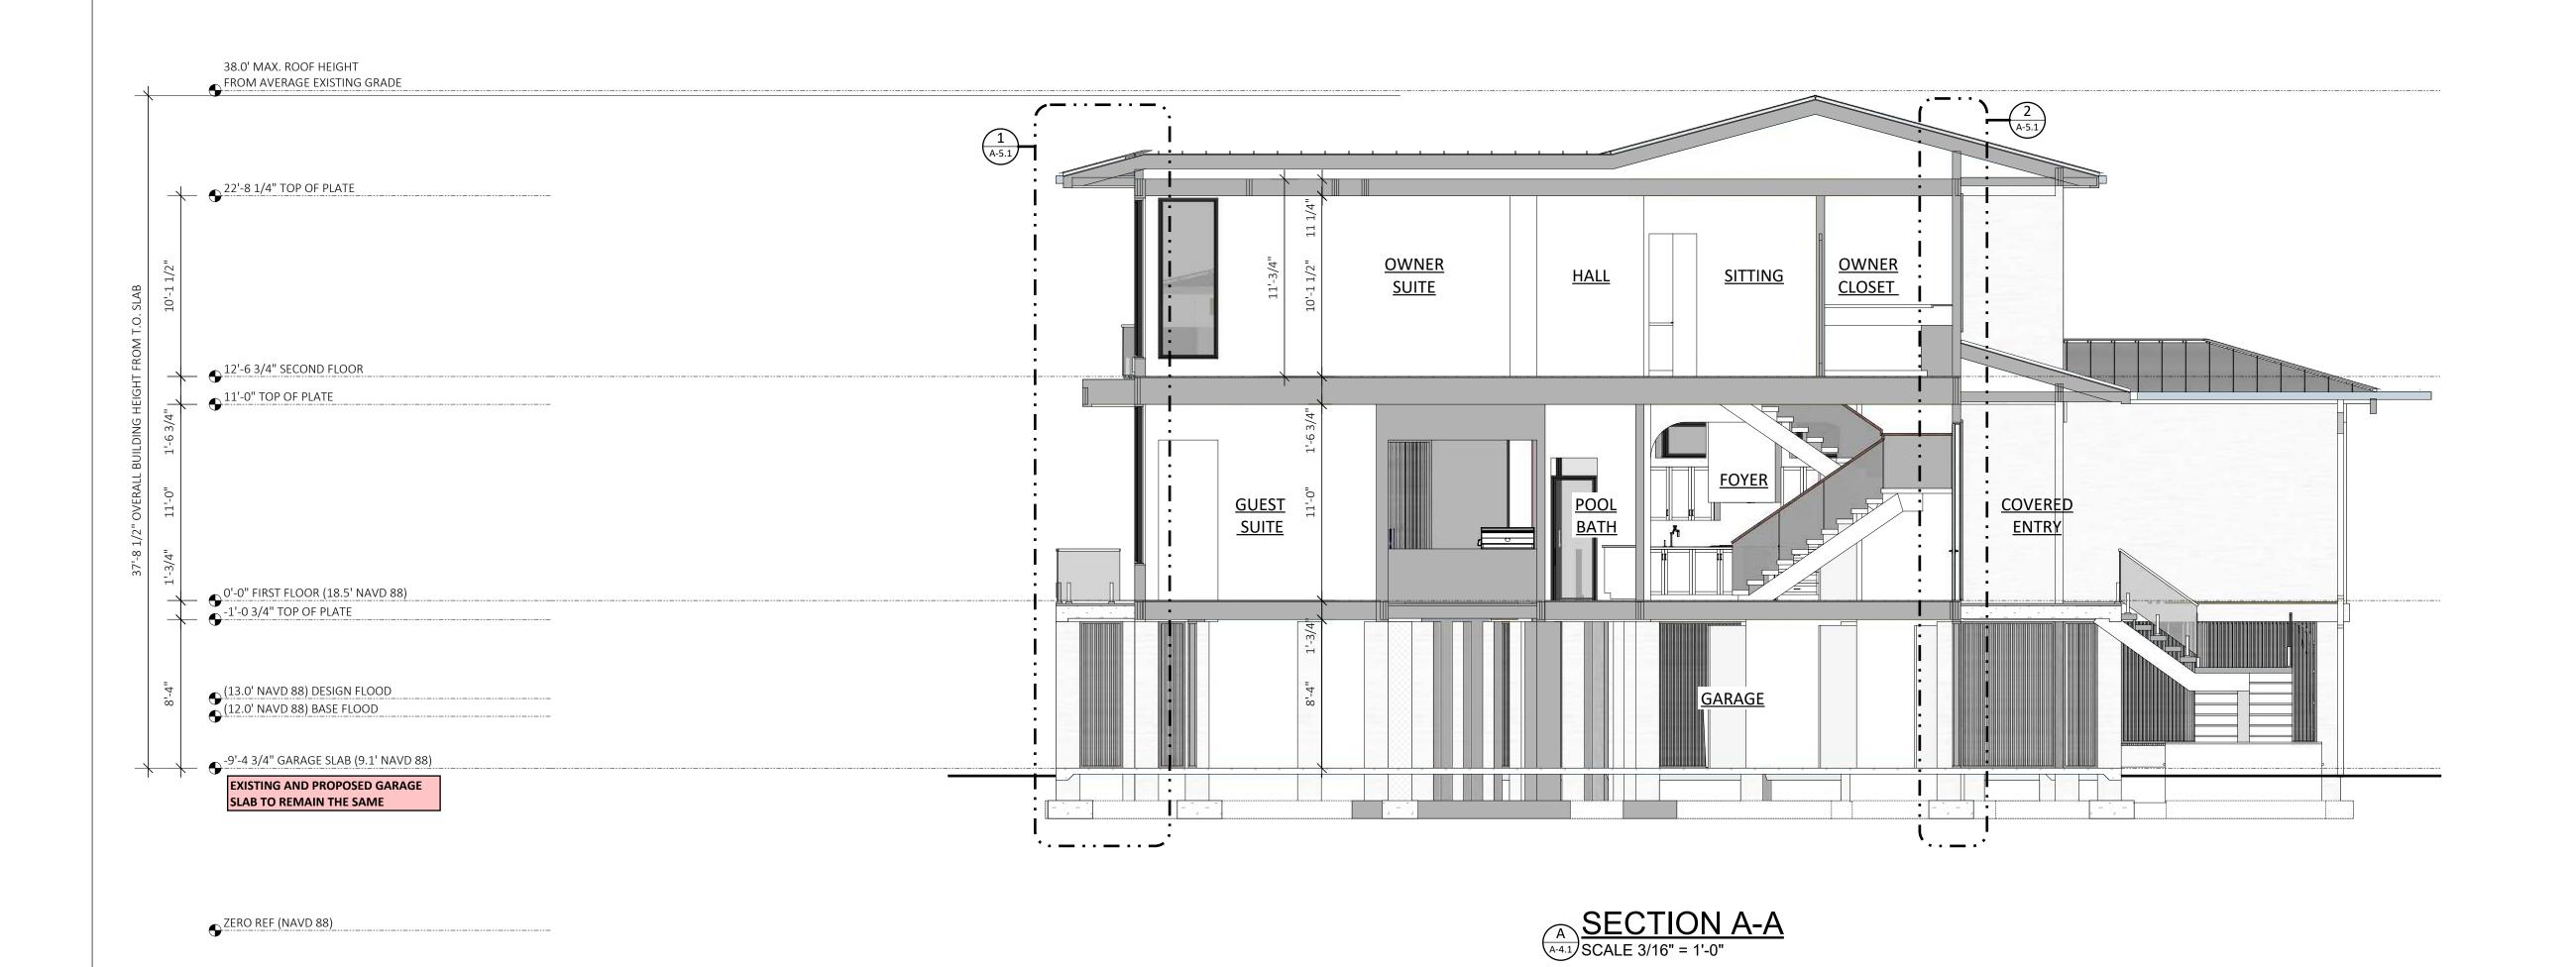

COPYRIGHT 2024 ALL RIGHTS COPYRIGHT 2024 ALL RIGHTS
RESERVED
IT IS A VIOLATION OF LAW FOR ANY
PERSON, UNLESS ACTING UNDER THE
DIRECTION OF DLB CUSTOM HOME
DESIGN, TO ALTER THIS DOCUMENT.
PRINTED OR ELECTRONIC DRAWINGS
AND DOCUMENTATION MAY NOT BE
REPRODUCED IN ANY FORM WITHOUT
WRITTEN PERMISSION. THIS DRAWING WAS PREPARED AT THE SCALE INDICATED. INACCURACIES IN THE STATED SCALE MAY BE INTRODUCED WHEN DRAWINGS ARE REPRODUCED BY ANY MEANS. USE THE GRAPHIC SCALE BAR TO DETERMINE THE ACTUAL SCALE.

BARKOWITZ RESIDENCE
ARCHITECTURAL PLANS
3203 MARSHALL BLVD.
SULLIVANS ISLAND
CHARLESTON COUNTY, SC
LOT 1, BLOCK 16,

JOB NO.: DESIGN BY:

DRAWN BY: 6/18/2025

DATE: SCALE: 1/4" = 1'-0" U.N.O.

BUILDING SECTION AND DETAILS

SHEET NO.



COPYRIGHT 2024 ALL RIGHTS COPYRIGHT 2024 ALL RIGHTS
RESERVED
IT IS A VIOLATION OF LAW FOR ANY
PERSON, UNLESS ACTING UNDER THE
DIRECTION OF DLB CUSTOM HOME
DESIGN, TO ALTER THIS DOCUMENT.
PRINTED OR ELECTRONIC DRAWINGS
AND DOCUMENTATION MAY NOT BE
REPRODUCED IN ANY FORM WITHOUT
WRITTEN PERMISSION. THIS DRAWING WAS PREPARED AT THE SCALE INDICATED. INACCURACIES IN THE STATED SCALE MAY BE INTRODUCED WHEN DRAWINGS ARE REPRODUCED BY ANY MEANS. USE THE GRAPHIC SCALE BAR TO DETERMINE THE ACTUAL SCALE.

BARKOWITZ RESIDENCE
ARCHITECTURAL PLANS
3203 MARSHALL BLVD.
SULLIVANS ISLAND
CHARLESTON COUNTY, SC
LOT 1, BLOCK 16,


JOB NO.: DESIGN BY:

DRAWN BY: DATE: 6/18/2025

SCALE: 1/4" = 1'-0" U.N.O.

BUILDING SECTION AND DETAILS

SHEET NO.

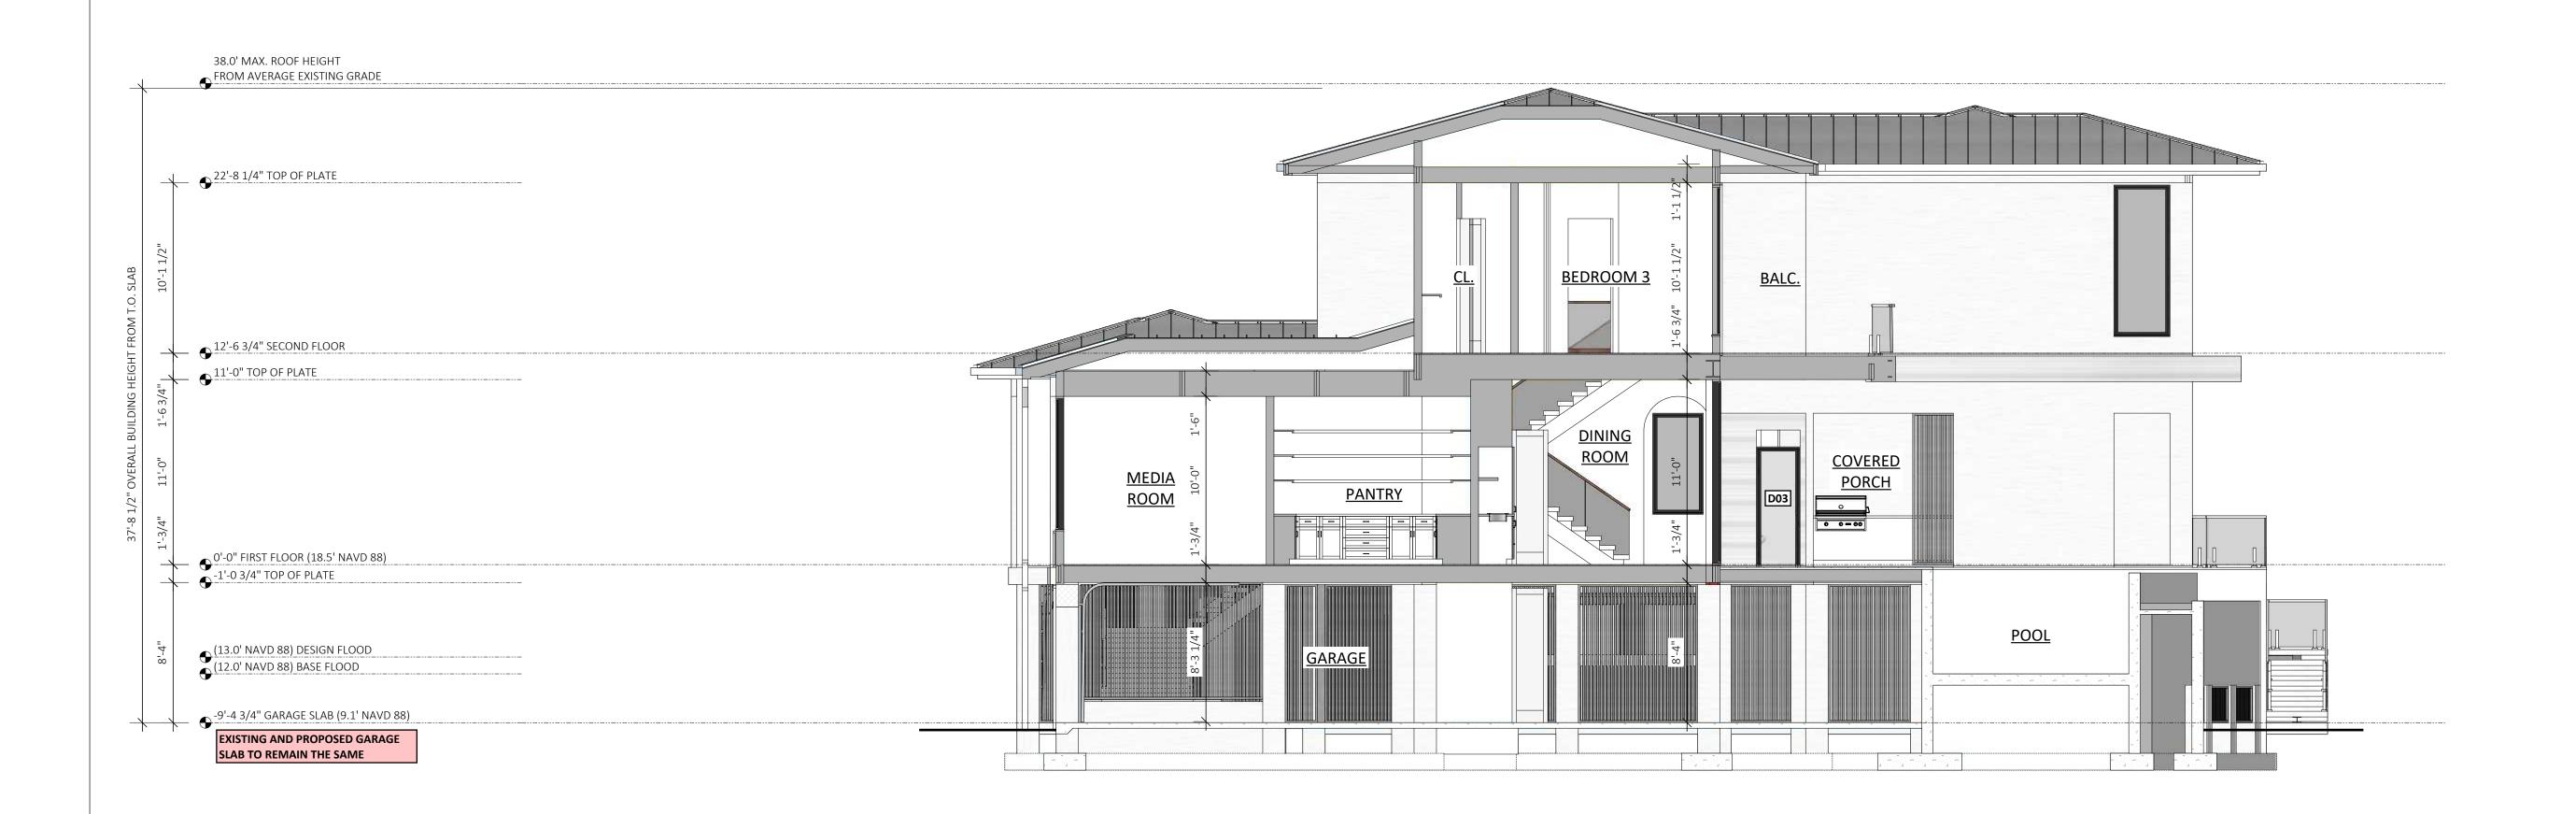

SECTION C-C SCALE 3/16" = 1'-0"
 NO.
 REVISION DESCRIPTION
 DATE

 1
 CONCEPTUAL DESIGN
 07/19/24

 2
 DRB FINAL SUBMITTAL
 01/15/25

 3
 BID SET
 01/29/25

 4
 PERMIT REVIEW SET
 03/20/25

 5
 PERMIT COMMENTS
 06/04/25

 6
 PERMIT COMMENTS
 7/3/2025

DLB DLB AND BOTH TO THE CHART THE CHART THE CHART TO THE

Busillo Charleston, SC AR.9183

COPYRIGHT 2024 ALL RIGHTS
RESERVED
IT IS A VIOLATION OF LAW FOR ANY
PERSON, UNLESS ACTING UNDER THE
DIRECTION OF DLB CUSTOM HOME
DESIGN, TO ALTER THIS DOCUMENT.
PRINTED OR ELECTRONIC DRAWINGS
AND DOCUMENTATION MAY NOT BE
REPRODUCED IN ANY FORM WITHOUT
WRITTEN PERMISSION.
THIS DRAWING WAS PREPARED AT
THE SCALE INDICATED.
INACCURACIES IN THE STATED
SCALE MAY BE INTRODUCED WHEN
DRAWINGS ARE REPRODUCED BY
ANY MEANS. USE THE GRAPHIC
SCALE BAR TO DETERMINE THE
ACTUAL SCALE.

PHONE: 843-303-2979

PHONE: 843-303-2979

WWW.DLBCUSTOMHOMEDESIGN.COM

DALY AND SAWYER

CONSTRUCTION CO

855 COLEMAN BLVD

MT DI FASANT SC 29464

BARKOWITZ RESIDENCE
ARCHITECTURAL PLANS
3203 MARSHALL BLVD.
SULLIVANS ISLAND
CHARLESTON COUNTY, SC
LOT 1, BLOCK 16,

JOB NO.: 2411

DESIGN BY: DLB

DRAWN BY: DLB

DATE: 6/18/2025

SCALE: 1/4" = 1'-0" U.N.O.

BUILDING SECTION AND DETAILS

SHEET NO.



SECTION D-D
SCALE 3/16" = 1'-0"

DLB

Custom Home

Charleston, SC

Charleston,

PYRIGHT 2024 ALL RIGHTS
ERVED
BY VOLATION OF LAW FOR A
SERVED SA VIOLATION OF LAW FOR A
SERVED SA V

COPYRIGHT 2024 ALL RIGHTS
RESERVED
IT IS A VIOLATION OF LAW FOR ANY
PERSON, UNLESS ACTING UNDER THE
DIRECTION OF DLB CUSTOM HOME
DESIGN, TO ALTER THIS DOCUMENT.
PRINTED OR ELECTRONIC DRAWINGS
AND DOCUMENTATION MAY NOT BE
REPRODUCED IN ANY FORM WITHOUT
WRITTEN PERMISSION.
THIS DRAWING WAS PREPARED AT
THE SCALE INDICATED.
INACCURACIES IN THE STATED
SCALE MAY BE INTRODUCED WHEN
DRAWINGS ARE REPRODUCED BY
ANY MEANS. USE THE GRAPHIC
SCALE BAR TO DETERMINE THE
ACTUAL SCALE.

PHONE: 843-203-2979
WWW.DLBCUSTOMHOMEDESIGN.COM
WWW.DLBCUSTOMHOMEDESIGN.COM

DALY AND SAWYER

CONSTRUCTION CO

855 COLEMAN BLVD
AT DIEASANT SC 20484

BARKOWITZ RESIDENCE
ARCHITECTURAL PLANS
3203 MARSHALL BLVD.
SULLIVANS ISLAND
CHARLESTON COUNTY, SC
LOT 1, BLOCK 16,

JOB NO.: 2411

DESIGN BY: DLB


DRAWN BY: DLB

DATE: 6/18/2025


SCALE: 1/4" = 1'-0" U.N.O.

BUILDING SECTION AND DETAILS

SHEET NO.

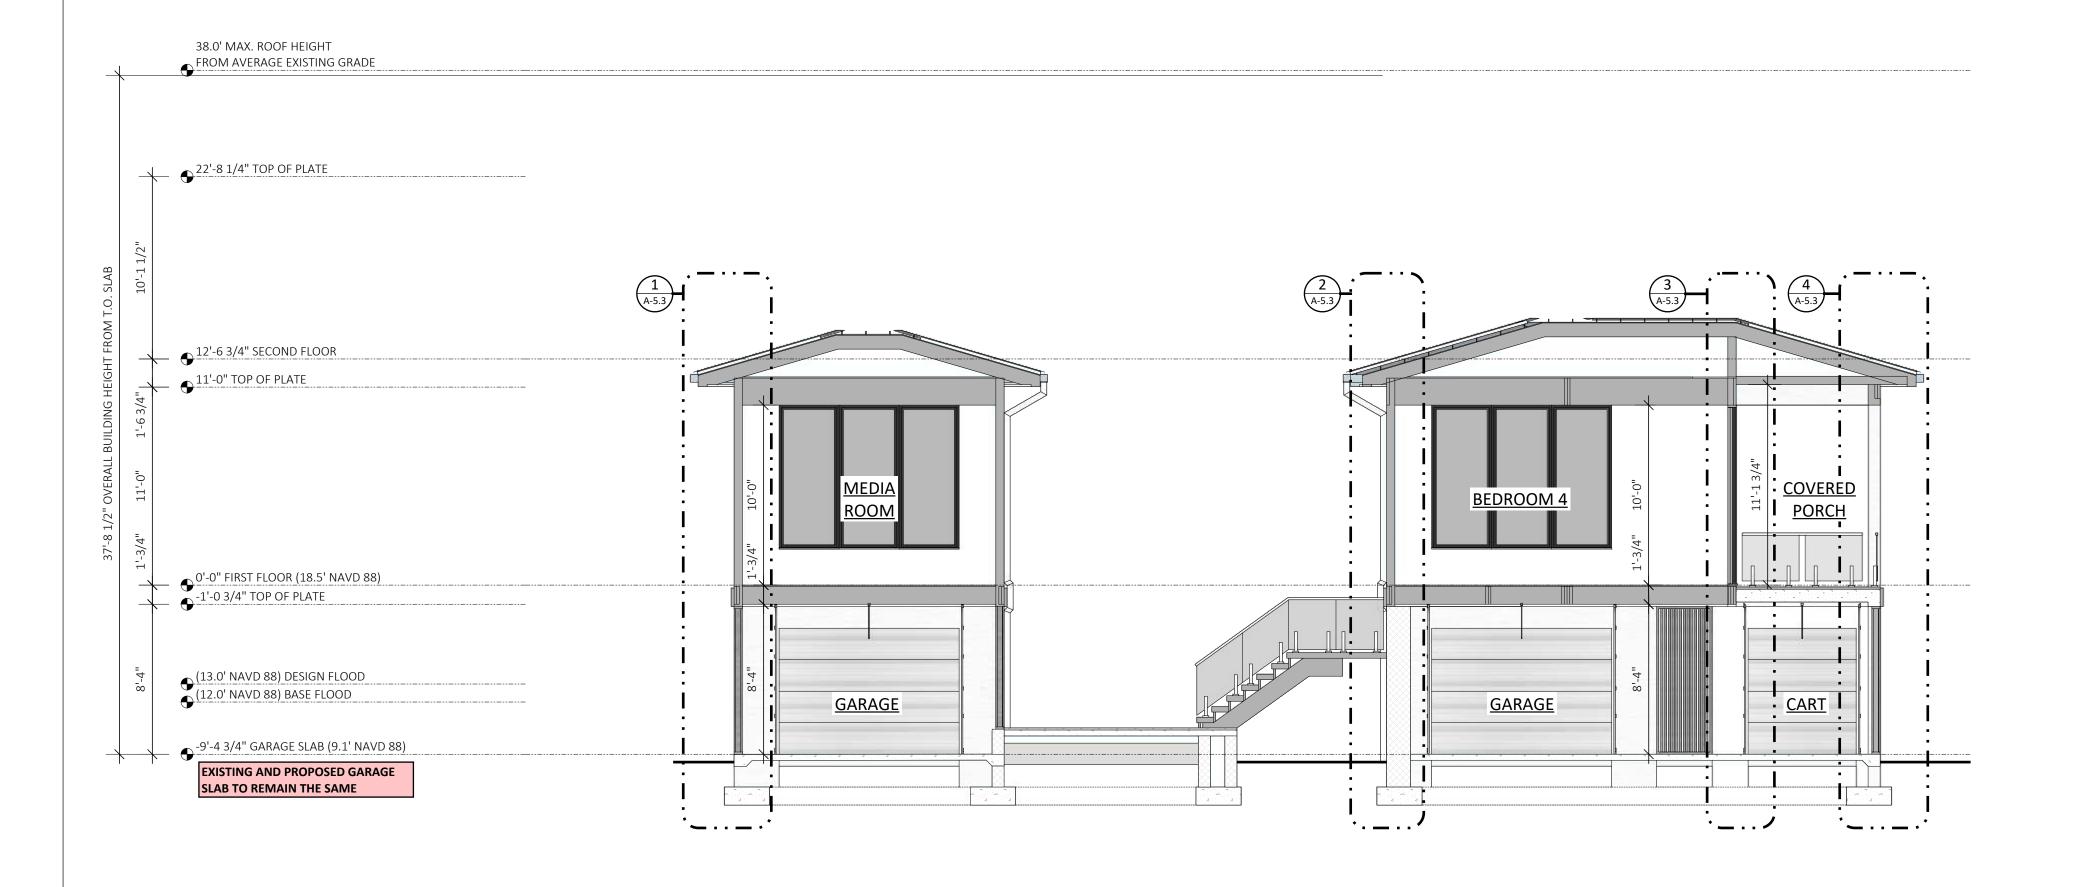

E SECTION E-E SCALE 3/16" = 1'-0"

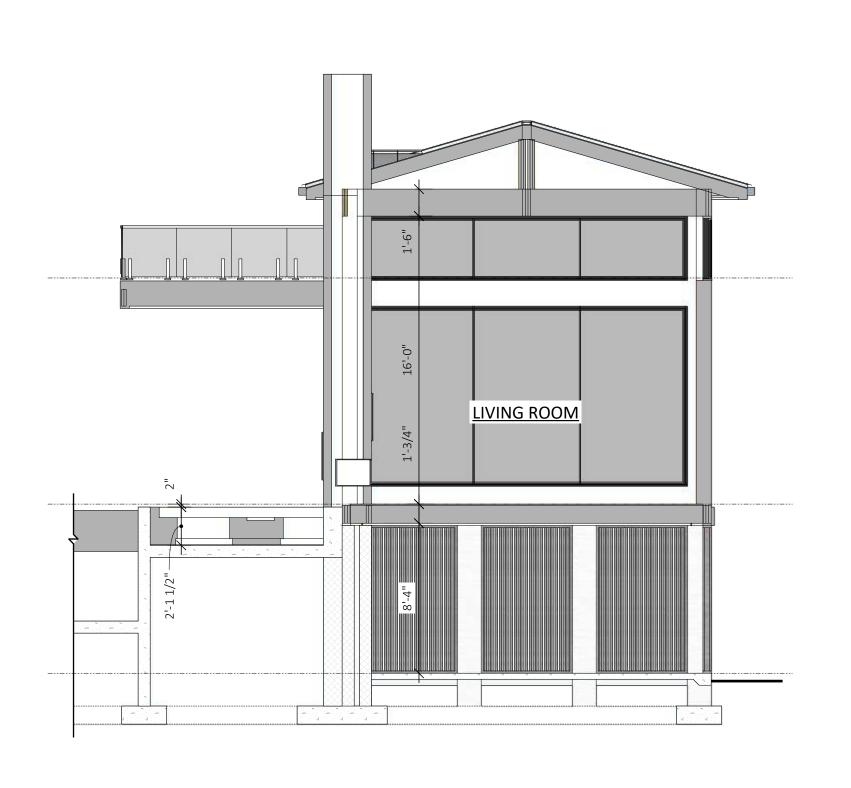

SECTION F-F
SCALE 3/16" = 1'-0"

 NO.
 REVISION DESCRIPTION
 DATE

 1
 CONCEPTUAL DESIGN
 07/19/24

 2
 DRB FINAL SUBMITTAL
 01/15/25

 3
 BID SET
 01/29/25

 4
 PERMIT REVIEW SET
 03/20/25

 5
 PERMIT COMMENTS
 06/04/25

 6
 PERMIT COMMENTS
 7/3/2025

DLB DLB Custom Home Charleston, SC 101084

Charleston, SC AR.9183

COPYRIGHT 2024 ALL RIGHTS
RESERVED
IT IS A VIOLATION OF LAW FOR ANY
PERSON, UNLESS ACTING UNDER THE
DIRECTION OF DLB CUSTOM HOME
DESIGN, TO ALTER THIS DOCUMENT.
PRINTED OR ELECTRONIC DRAWINGS
AND DOCUMENTATION MAY NOT BE
REPRODUCED IN ANY FORM WITHOUT
WRITTEN PERMISSION.
THIS DRAWING WAS PREPARED AT
THE SCALE INDICATED.
INACCURACIES IN THE STATED
SCALE MAY BE INTRODUCED WHEN
DRAWINGS ARE REPRODUCED BY
ANY MEANS. USE THE GRAPHIC
SCALE BAR TO DETERMINE THE
ACTUAL SCALE.

PHONE: 843-303-2979

PHONE: 843-303-2979

WWW.DLBCUSTOMHOMEDESIGN.COM

DALY AND SAWYER

CONSTRUCTION CO

855 COLEMAN BLVD

MT PI FASANT SC 29464

BARKOWITZ RESIDENCE
ARCHITECTURAL PLANS
3203 MARSHALL BLVD.
SULLIVANS ISLAND
CHARLESTON COUNTY, SC
LOT 1, BLOCK 16,

JOB NO.: 2411

DESIGN BY: DLB

DRAWN BY: DLB


DATE: 6/18/2025


SCALE: 1/4" = 1'-0" U.N.O.


SCALE: 1/4" = 1'-0'


BUILDING SECTION AND DETAILS

SHEET NO.

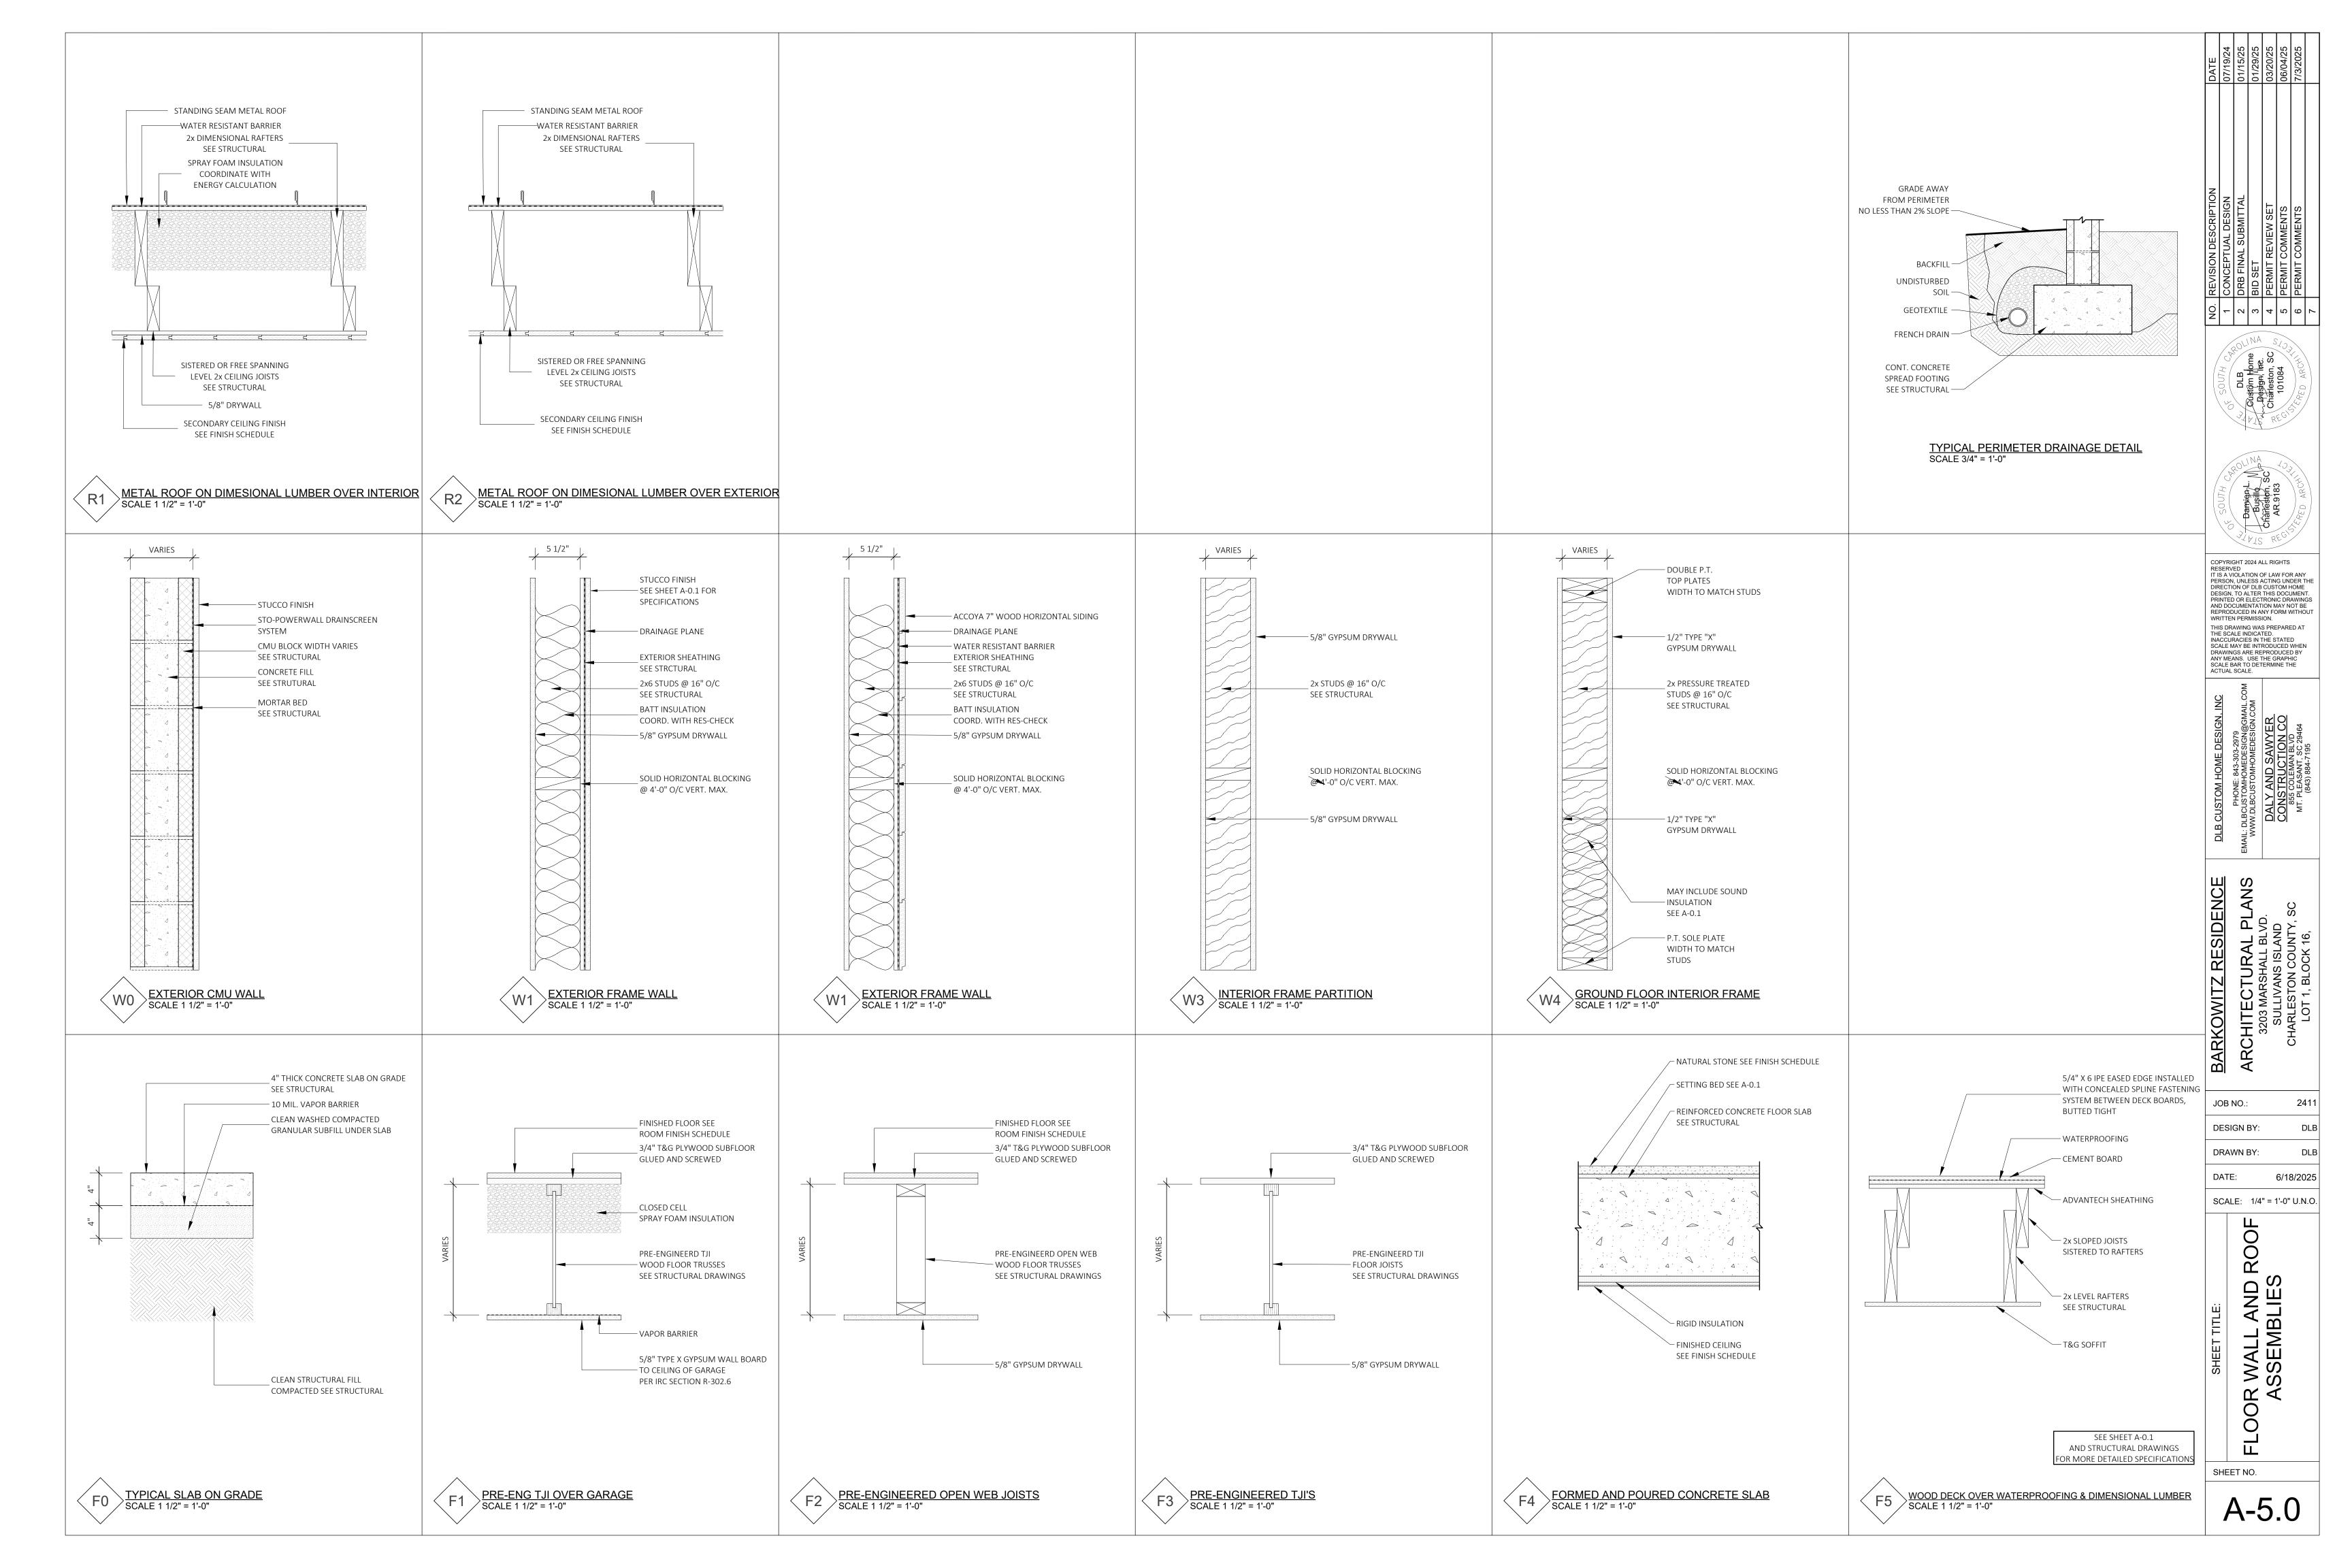


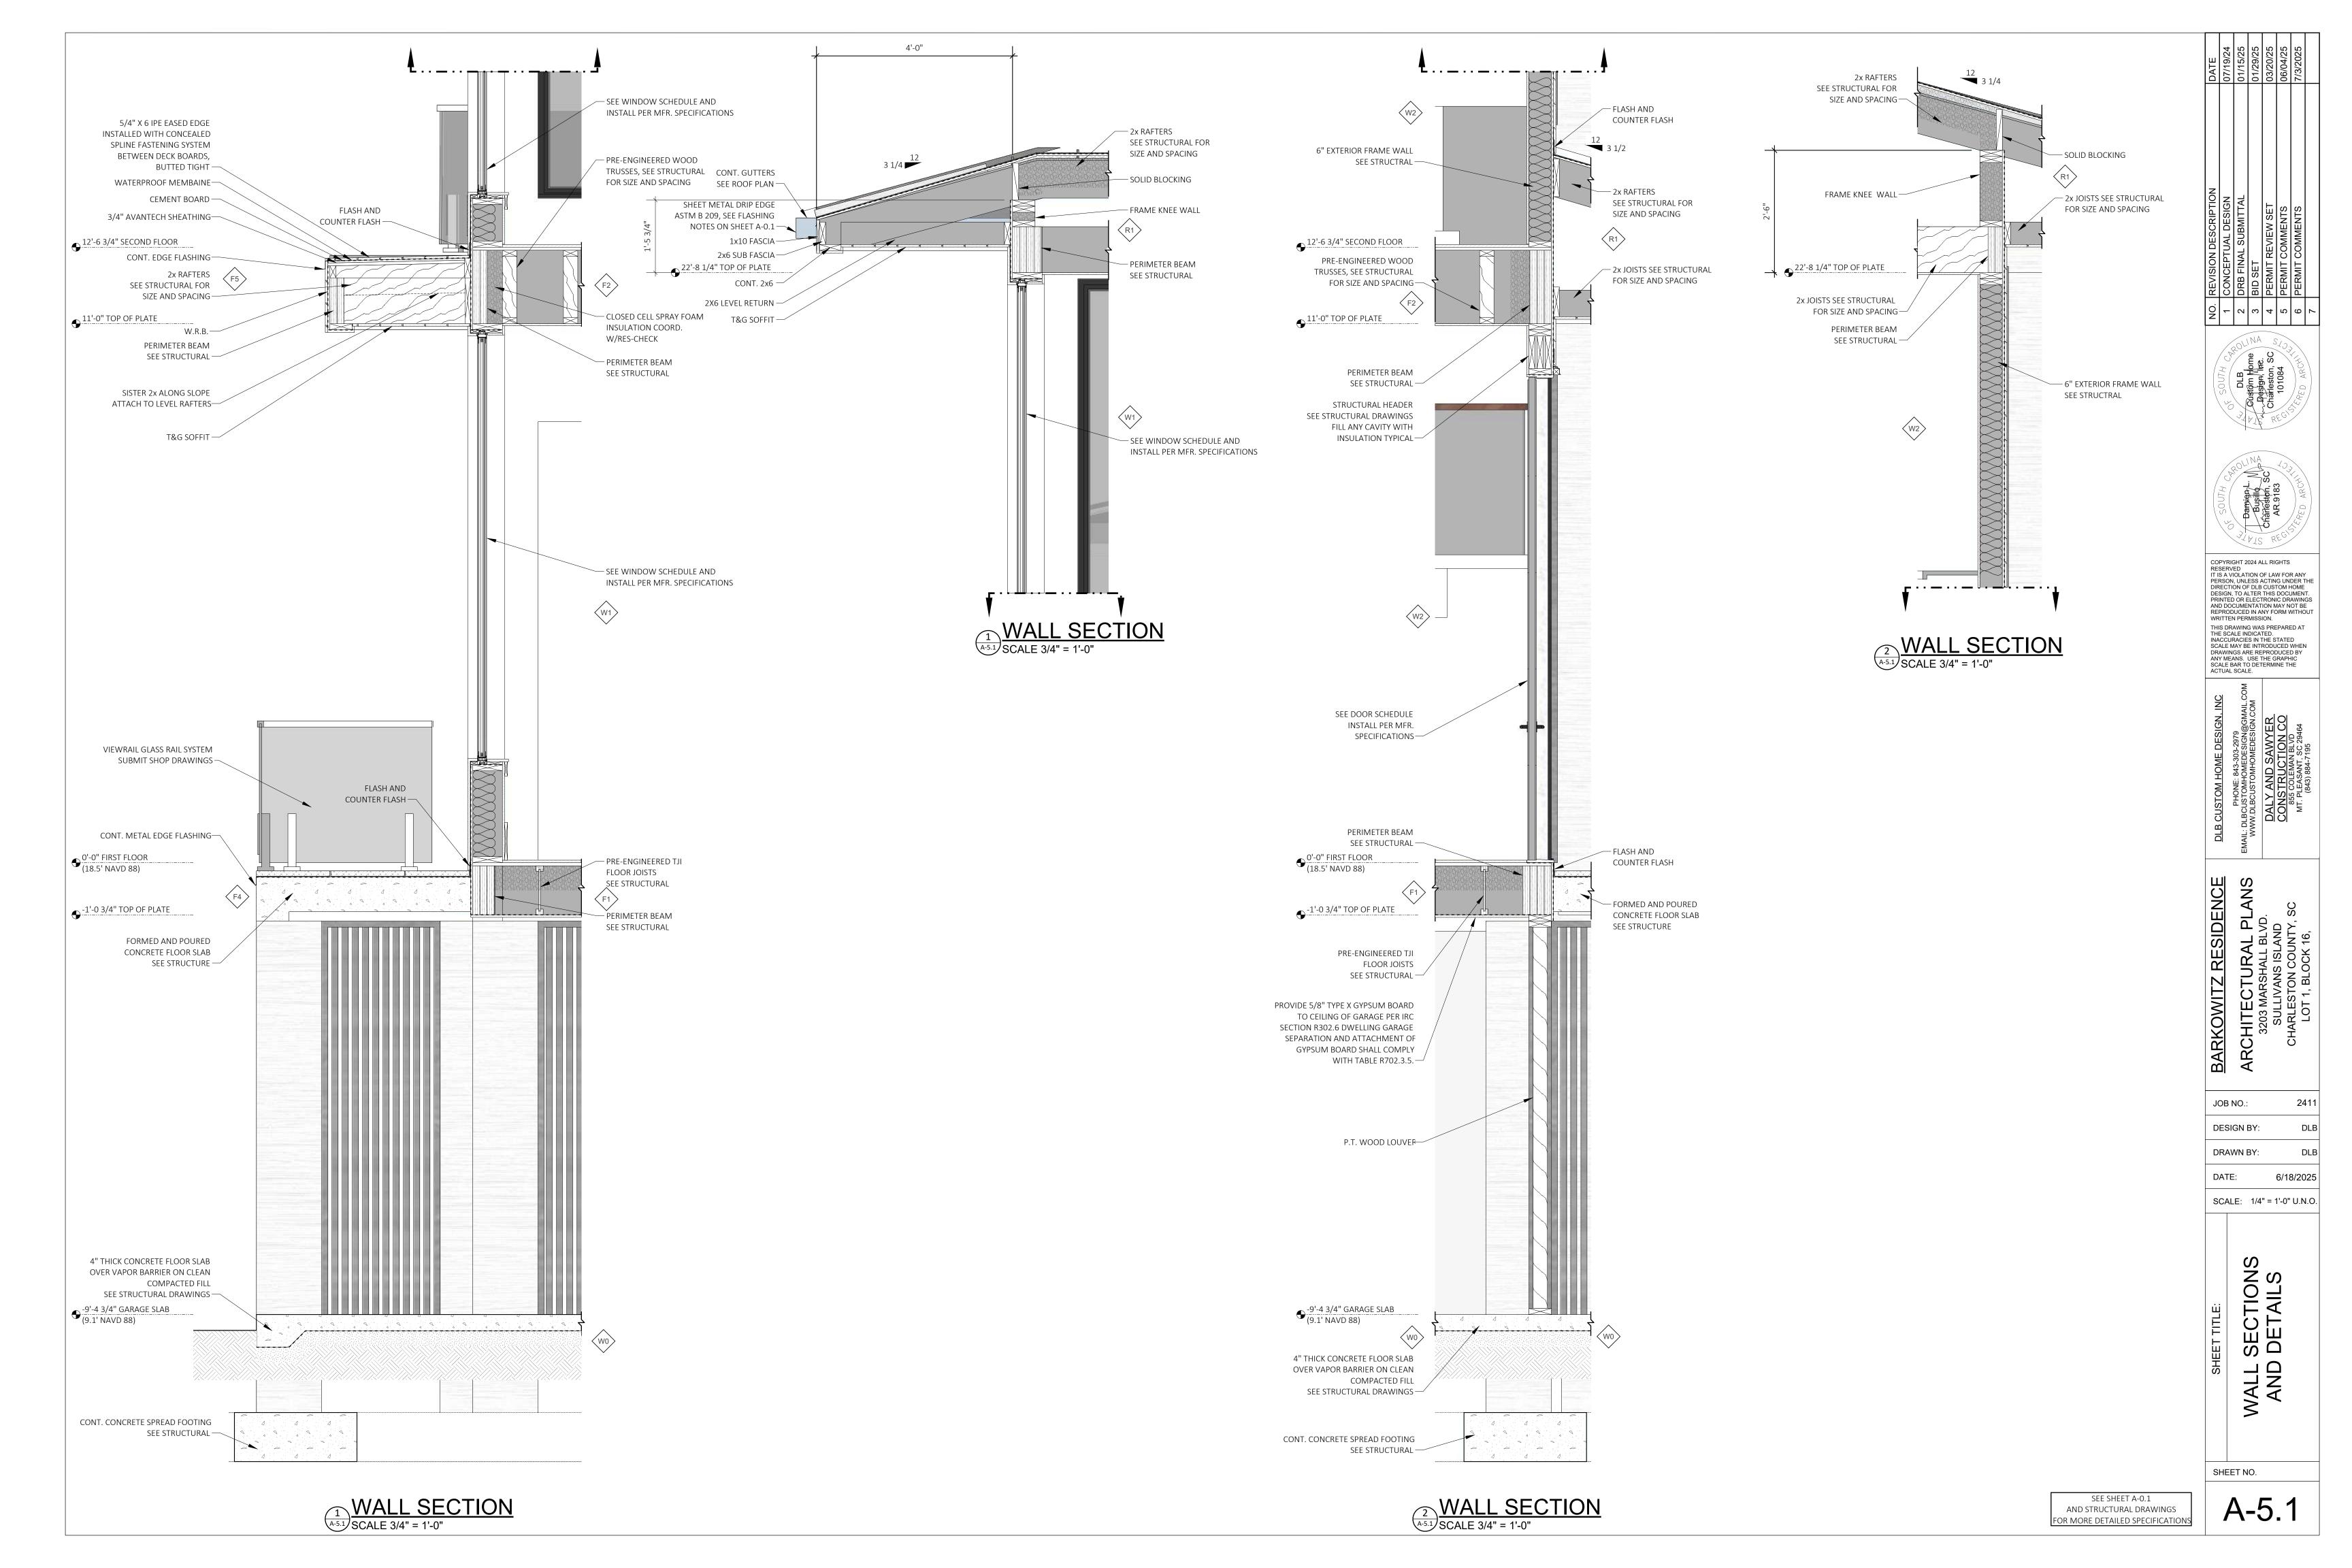

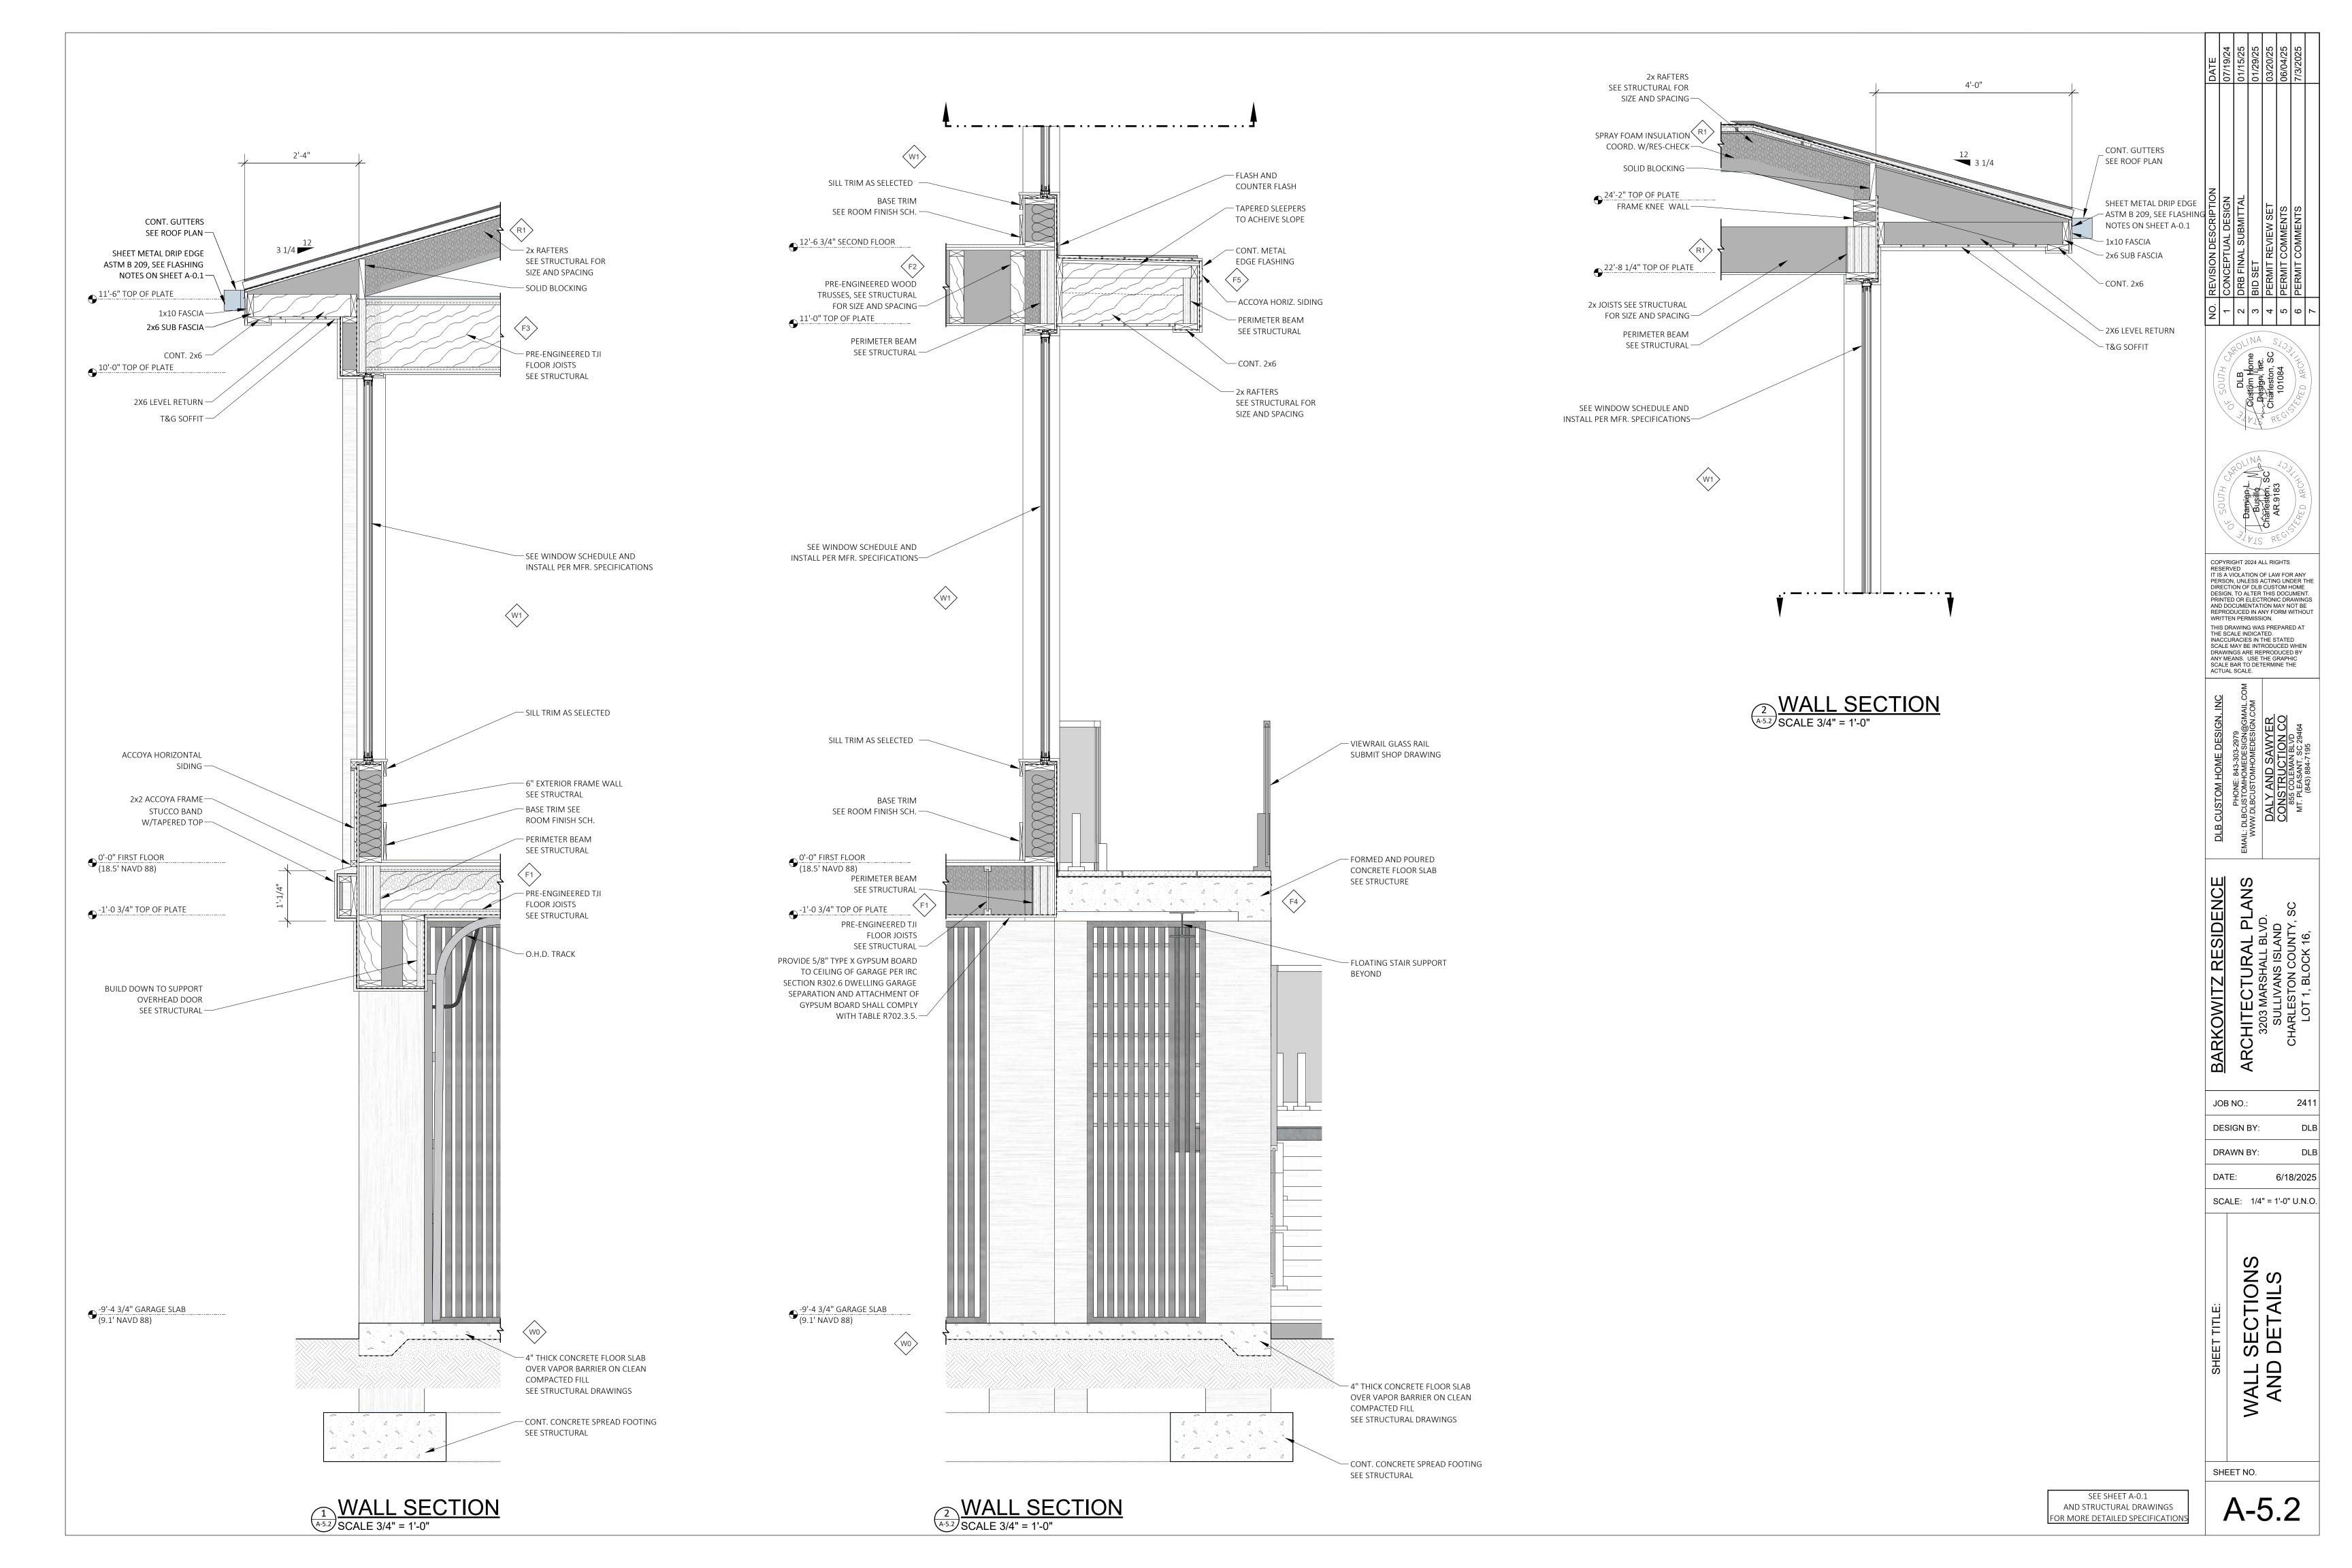

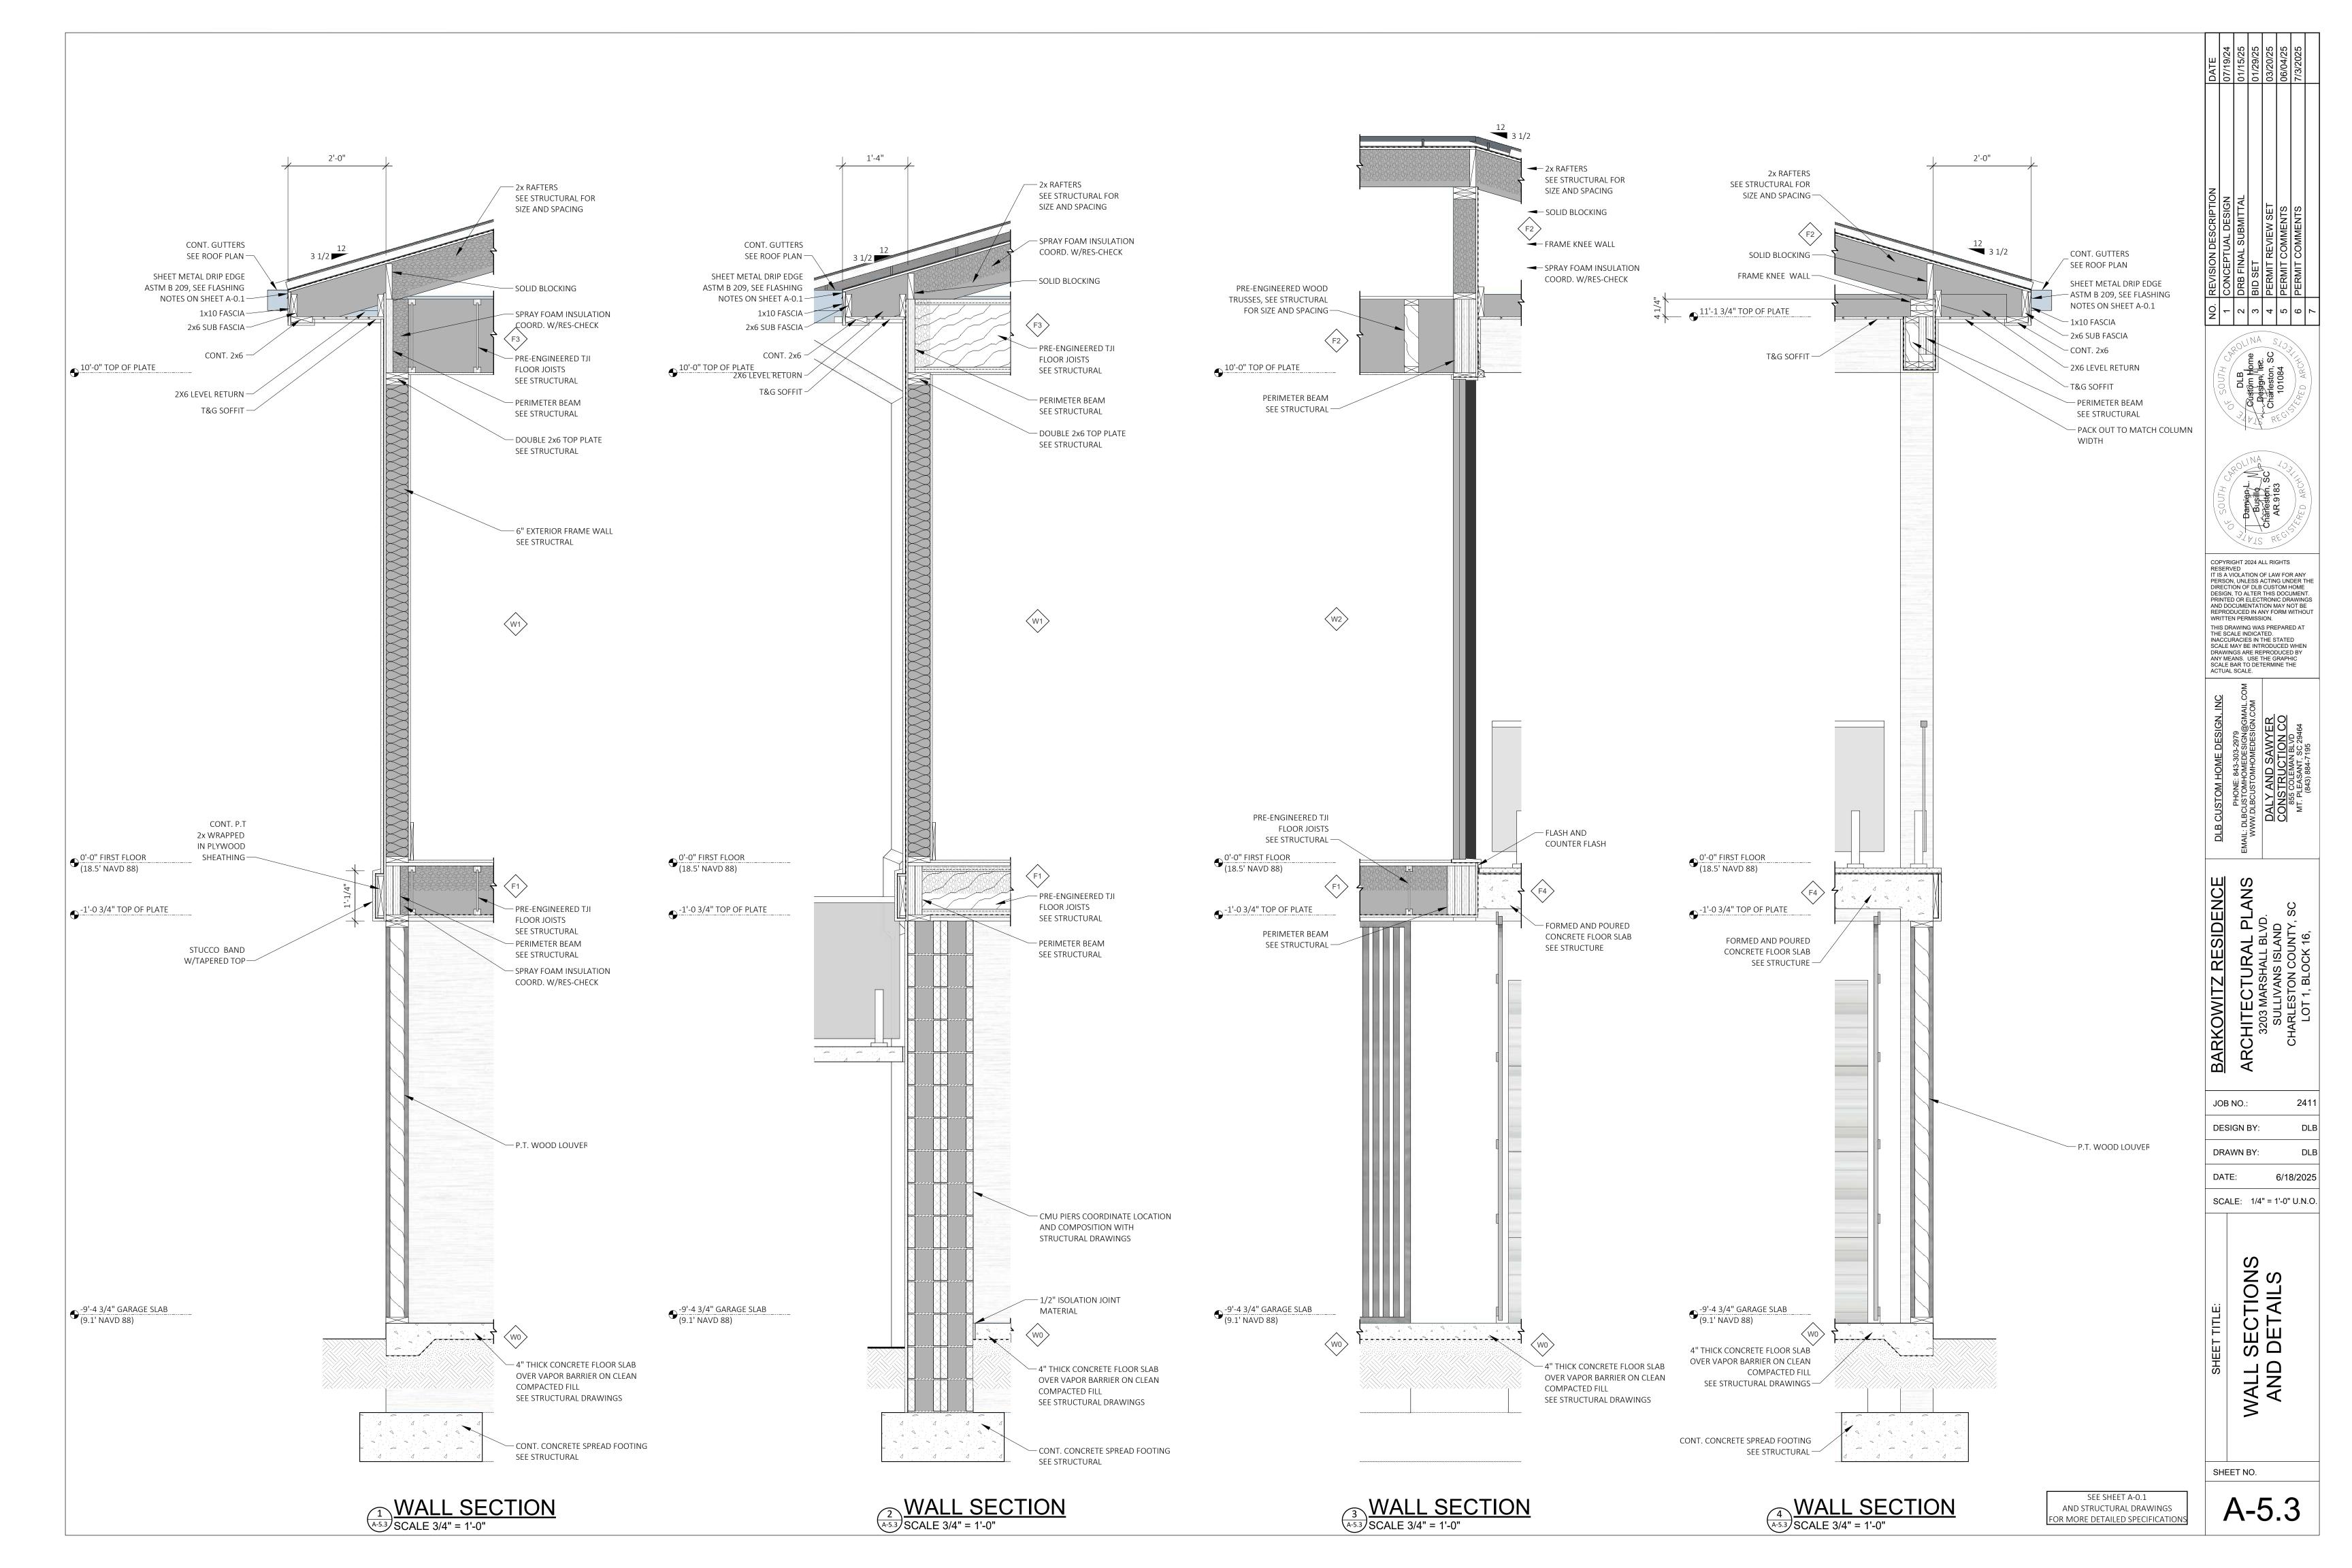

ELECTRICAL SYMBOLS LEGEND						
φ	DUPLEX RECEPTICAL AT 12' A.F.F.		RECEPTICAL 220 VOLT			
ФВ	DUPLEX RECEPTICAL IN BASEBOARD	φ	SINGLE RECEPTICAL DEDICATED			
P _C	DUPLEX RECEPTICAL ABOVE COUNTER	Φ	SINGLE RECEPTICAL DEDICATED SWITCHED			
P GFI	DUPLEX RECEPTICAL GROUND FAULT	(i) Juc	RECEPTICAL UNDER COUNTER			
Ф С GFI	DUPLEX RECEPTICAL ABOVE COUNTER/GFI	Ø	DUPLEX RECEPTICAL ARC FAULT			
•	DUPLEX RECEPTICAL HALF SWITCHED	7	DUPLEX RECEPT. ARC FAULT 1/2 SWITCHED			
₩P GFI	DUPLEX RECEPTICAL WATER PROOF GFI	JB	JUNCTION BOX			
(i) HUC	DUPLEX RECEPTICAL UNDER COUNTER	FB	FAN BOX			
#	QUADPLEX RECEPTICAL WATER PROOF GFI	Д	ELECTRICAL METER			
	DUPLEX RECEPTICAL WATER PROOF GFI		SWITCH DISCONNECT			
₩ A	DUPLEX RECEPTICAL ABOVE		BREAKER PANEL			
\$	SWITCH SINGLE POLE		FLOURESENT LIGHT FIXTURE			
\$ ₃	SWITCH 3 WAY	\longrightarrow	FLOURESENT LIGHT STRIP FIXTURE			
\$4	SWITCH 4 WAY		INCANDESCENT LIGHT CEILING MOUNT			
\$_R	SWITCH RHIOSTAT	<u>-</u>	INCANDESCENT LIGHT WALL MOUNT			
\$	SWITCH DIMMER		RECESSED LIGHT FIXTURE			
\$ _K	SWITCH KEYED	√ P	RECESSED LIGHT VAPOR PROOF			
P	SWITCH PUSH BOTTON	©	RECESSED LIGHT FIXTURE, DIRECTIONAL			
K	SECURITY KEYPAD	TR	LOW VOLTAGE TRANSFORMER			
	DOOR CHIME	44	SECURITY LIGHT			
	LOW VOLTAGE DOOR RELEASE	坐	STEP LIGHT OR POST LIGHT, WATERPROOF			
(51)	SMOKE AND CARBON MONOXIDE DETECTOR	\otimes	SPEAKER IN CEILING			
SD	SMOKE DETECTOR LOW VOLTAGE	\bigcirc	VOLUME CONTROL			
(CM)	CARBON MONOXIDE DETECTOR	TY	TELEVISION JACK PREWIRE			
EF)	EXHAUST FAN	\	TELEPHONE OUTLET 12" A.F.F.			
, ()	EXHAUST FAN / LIGHT COMBO	8	TELEPHONE OUTLET FLUSH IN FLOOR			
\times	CEILING FAN		PHONE / DATA OUTLET			
γ φ	HVAC THERMOSTAT	нв †	HOSE BIB			
· •	INTERCOM AT 60" A.F.F.	ı				
' CV '	CENTRAL VACUME INLET					

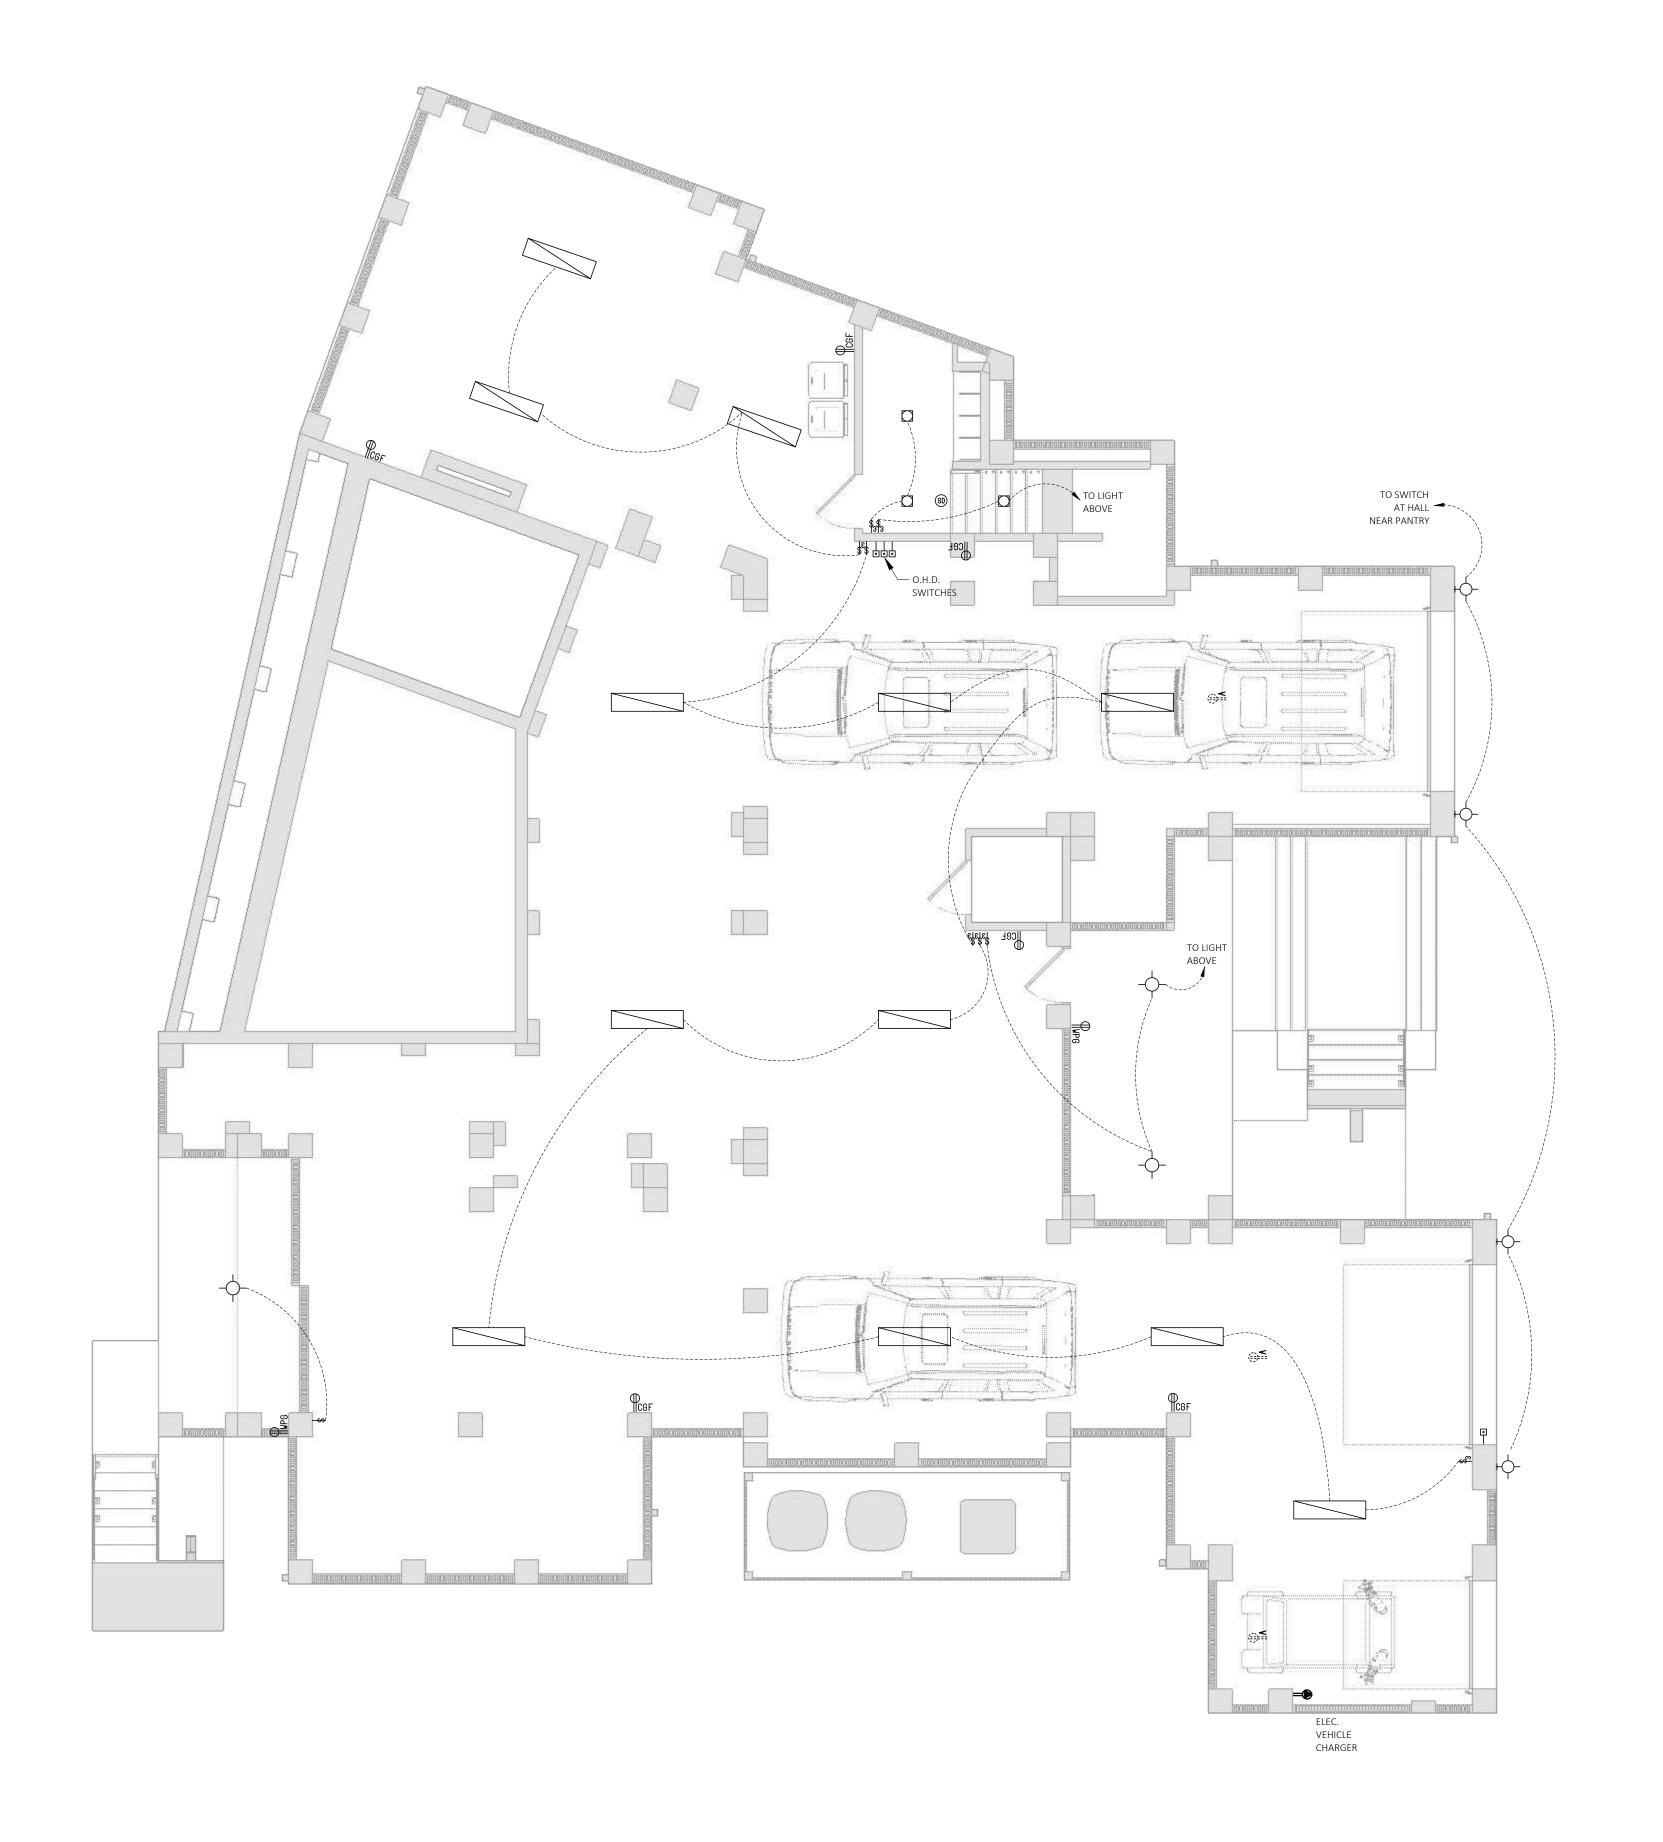



COPYRIGHT 2024 ALL RIGHTS COPYRIGHT 2024 ALL RIGHTS
RESERVED
IT IS A VIOLATION OF LAW FOR ANY
PERSON, UNLESS ACTING UNDER THE
DIRECTION OF DLB CUSTOM HOME
DESIGN, TO ALTER THIS DOCUMENT.
PRINTED OR ELECTRONIC DRAWINGS
AND DOCUMENTATION MAY NOT BE
REPRODUCED IN ANY FORM WITHOUT
WRITTEN PERMISSION. THIS DRAWING WAS PREPARED AT THE SCALE INDICATED.
INACCURACIES IN THE STATED SCALE MAY BE INTRODUCED WHEN DRAWINGS ARE REPRODUCED BY ANY MEANS. USE THE GRAPHIC SCALE BAR TO DETERMINE THE ACTUAL SCALE.

JOB NO.: DESIGN BY:

DATE: 6/18/2025 SCALE: 1/4" = 1'-0" U.N.O.

ALL SWITCHES FOR RECESSED LIGHTS AND SURFACE MOUNTED TO HAVE DIMMER CONTROLS. TIMER SWITCHING FOR

DRAWN BY:

GENERAL ELECTRICAL NOTES

ALL SYMBOLS SHOW THE DESIRED LOCATIONS AND WILL BE FINALIZED DURING THE WALK-THROUGH WITH THE

VERIFY AND COORDINATE ALL POWER REQUIREMENTS FOR EQUIPMENT AND APPLIANCES WITH OWNER AND

VERIFY WITH OWNER ALL LOCATIONS FOR CABLE, INTERNET, AND PHONE LOCATIONS.
PROVIDE SMOKE AND CARBON MONOXIDE DETECTORS AS SELECTED BY OWNER. PROVIDE ALLOWANCE FOR WIFI ACCESS POINTS, CAMERAS AND SOME DETECTORS.

COORDINATE ALL LANDSCAPE AND EXTERIOR LIGHTING WITH THE LANDSCAPE ARCHITECT AND CONTRACTOR. PROVIDE ALLOWANCE FOR SECURITY AND ALARM SYSTEM AND WIRING AS SELECTED BY OWNER.

PROVIDE CENTRAL VACUUM. VERIFY DISTANCES OF VACUUM LOCATIONS WITH MANUFACTURER. PROVIDE CABINET

E4203.1.3 NOT LESS THAN ONE 125 VOLT, 15 OR 20 AMPERE RECEPTICAL SUPPLIED BY A GENERAL-PURPOSE BRANCH CIRCUIT SHALL BE LOCATED NOT LESS THAN 6 FEET FROM AND NOT MORE THAN 20 FEET FROM THE INSIDE WALL OF

PERMANENTLY INSTALLED POOLS AND OUTDOOR SPAS AND HOT TUBS. THIS RECEPTICAL SHALL BE LOCATED NOT MORE THAN 6 FEET, 6 INCHES ABOVE THE FLOOR, PLATFORM OR GRADE LEVEL SERVING THE POOL, SPA OR HOT TUB.

ELECTRICIAN. ADDITIONAL LOCATIONS MAY BE REQUIRED BY CODE.

PROVIDE BUILT IN LIGHTING IN THE MASTER CLOSET CABINETRY

EXHAUST FANS 110 CFM MIN. VENTED TO OUTSIDE.

VAC AT KITCHEN ISLAND AND CEILING MOUNTED VACUUM IN BETWEEN GARAGE BAYS PROVIDE IN LINE DAMPERS FOR EXHAUST FANS. TO BE PLASTIC W/ RUBBER GASKETS

OVERHEAD DOOR RECEPTICALS IN GARAGE SHALL HAVE GROUND FAULT INTERUPT PROTECTION. PLACE ARC FAULT RECEPTICALS WHERE REQIRED AND IN COMPLIANCE WITH 2021 IRC E3 209.16

PLACE TAMPER RESISTANT RECEPTICALS WHERE REQUIRED AND IN COMPLIANCE WITH 2021 IRC E 4002.14


ALL EXHAUST FANS

ARCHITECT

FLOOR AL PLAN 680.22(A)(1)
E3901.7 OUTDOOR OUTLETS. NOT LESS THAN ONE RECEPTICAL OUTLET THAT IS READILY ACCESSIBLE FROM GRADE
LEVEL AND LOCATED NOT MORE THAN 6'-6" ABOVE GRADE, SHALL BE INSTALLED OUTDOORS AT THE FRONT AND BACK OF EACH DWELLING UNIT HAVING DIRECT ACCESS TO GRADE LEVEL. BALCONIES, DECKS AND PORCHES THAT ARE ACCESSIBLE FROM INSIDE WITHEN 4" HORIZONTALLY OF THE DWELLING UNIT SHALL HAVE AT LEAST ONE RECEPTICAL OUTLET ACCESSIBLE FROM THE BALCONY, DECK OR PORCH. THE RECEPTICAL SHALL BE LOCATED NOT MORE THAN 6'-6" ABOVE THE BALCONY, DECK OR PORCH SURFACE. 210.52(E)

GROUND I

<u></u>	ELECTRICAL S	<u> </u>	RECEPTICAL
₽	AT 12' A.F.F.	Ť	220 VOLT
B	DUPLEX RECEPTICAL IN BASEBOARD	φ	SINGLE RECEPTICAL DEDICATED
	DUPLEX RECEPTICAL ABOVE COUNTER	•	SINGLE RECEPTICAL DEDICATED SWITCHED
P GFI	DUPLEX RECEPTICAL GROUND FAULT	Ú) UC	RECEPTICAL UNDER COUNTER
D C GFI	DUPLEX RECEPTICAL ABOVE COUNTER/GFI	9	DUPLEX RECEPTICAL ARC FAULT
•	DUPLEX RECEPTICAL HALF SWITCHED	7	DUPLEX RECEPT. ARC FAULT 1/2 SWITCHED
WP GFI	DUPLEX RECEPTICAL WATER PROOF GFI	JB	JUNCTION BOX
(I) HUC	DUPLEX RECEPTICAL UNDER COUNTER	FB	FAN BOX
₩	QUADPLEX RECEPTICAL WATER PROOF GFI	Д	ELECTRICAL METER
	DUPLEX RECEPTICAL WATER PROOF GFI	ㅁ	SWITCH DISCONNECT
(I) A	DUPLEX RECEPTICAL ABOVE		BREAKER PANEL
\$	SWITCH SINGLE POLE		FLOURESENT LIGHT FIXTURE
\$ 3	SWITCH 3 WAY		FLOURESENT LIGHT STRIF FIXTURE
\$_4	SWITCH 4 WAY		INCANDESCENT LIGHT CEILING MOUNT
\$ _R	SWITCH RHIOSTAT	-ф-	INCANDESCENT LIGHT WALL MOUNT
\$	SWITCH DIMMER		RECESSED LIGHT FIXTURE
\$ _K	SWITCH KEYED		RECESSED LIGHT VAPOR PROOF
Ť	SWITCH PUSH BOTTON	©	RECESSED LIGHT FIXTURE, DIRECTIONAL
K T	SECURITY KEYPAD	TR	LOW VOLTAGE TRANSFORMER
	DOOR CHIME	464	SECURITY LIGHT
P	LOW VOLTAGE DOOR RELEASE	*	STEP LIGHT OR POST LIGHT, WATERPROOF
D	SMOKE AND CARBON MONOXIDE DETECTOR	\otimes	SPEAKER IN CEILING
6D	SMOKE DETECTOR LOW VOLTAGE	\bigcirc	VOLUME CONTROL
	CARBON MONOXIDE DETECTOR	TV I	TELEVISION JACK PREWIRE
	EXHAUST FAN	\blacksquare	TELEPHONE OUTLET 12" A.F.F.
Þ	EXHAUST FAN / LIGHT COMBO	8	TELEPHONE OUTLET FLUSH IN FLOOR
	CEILING FAN	1	PHONE / DATA OUTLET
₽	HVAC THERMOSTAT	нв †	HOSE BIB
· ⊋	INTERCOM AT 60" A.F.F.	'	

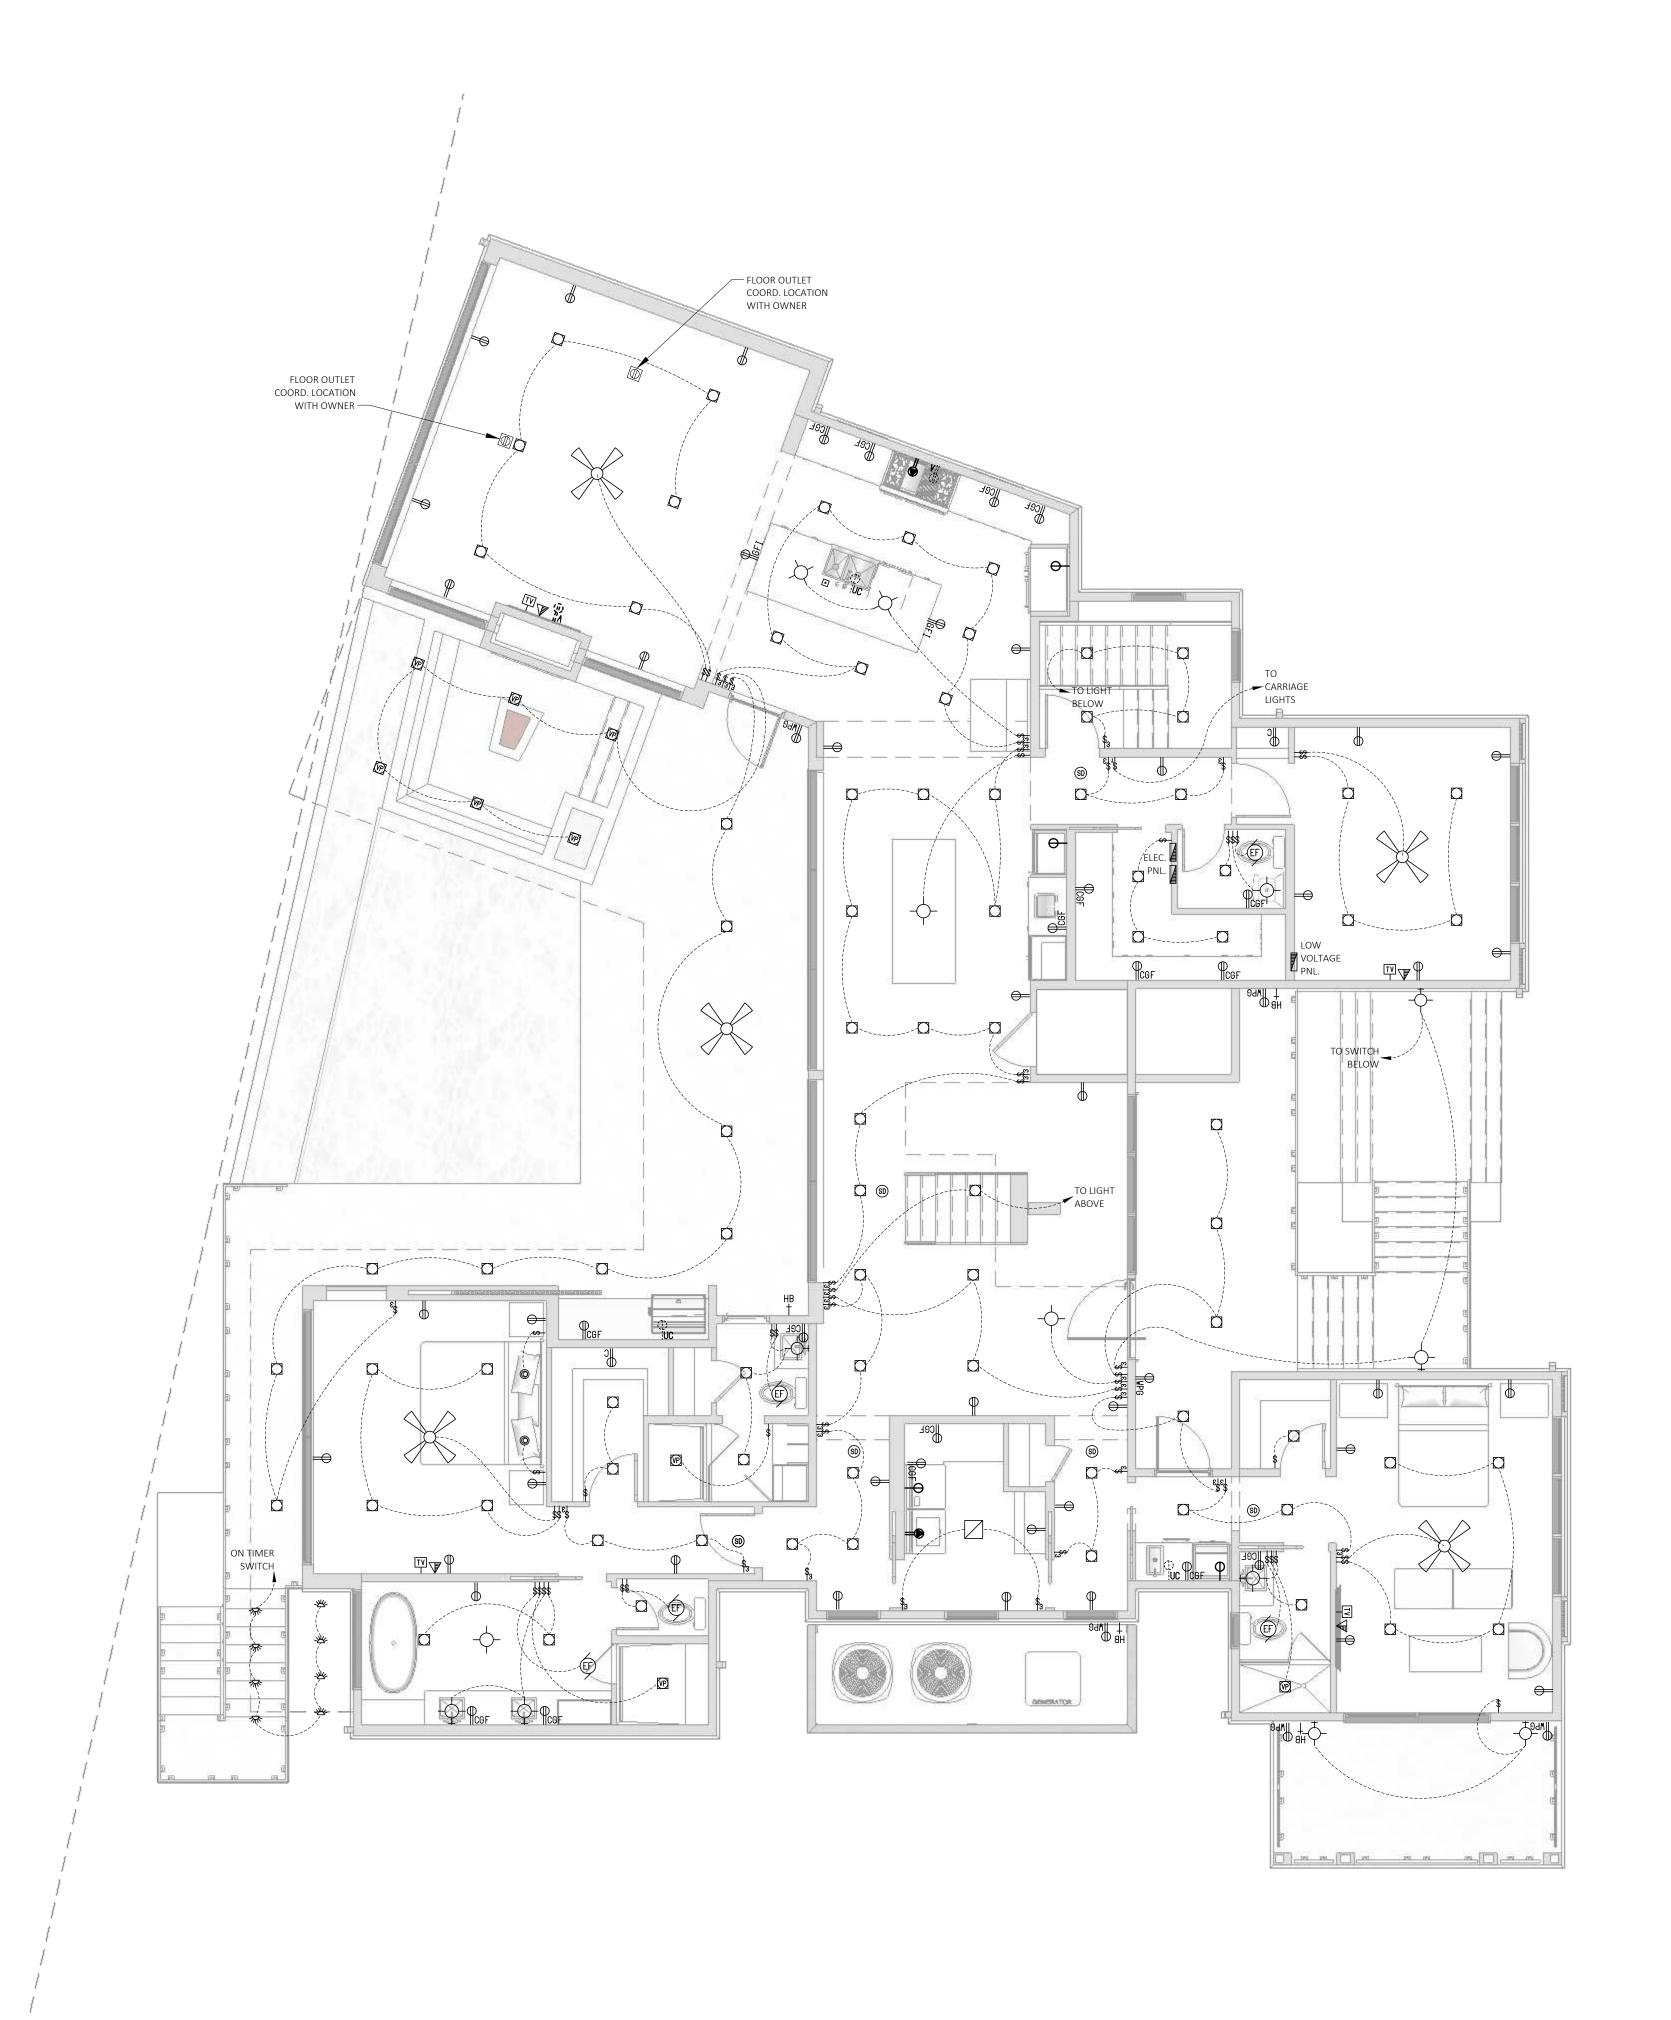





COPYRIGHT 2024 ALL RIGHTS COPYRIGHT 2024 ALL RIGHTS
RESERVED
IT IS A VIOLATION OF LAW FOR ANY
PERSON, UNLESS ACTING UNDER THE
DIRECTION OF DLB CUSTOM HOME
DESIGN, TO ALTER THIS DOCUMENT.
PRINTED OR ELECTRONIC DRAWINGS
AND DOCUMENTATION MAY NOT BE
REPRODUCED IN ANY FORM WITHOUT
WRITTEN PERMISSION. THIS DRAWING WAS PREPARED AT THE SCALE INDICATED.
INACCURACIES IN THE STATED SCALE MAY BE INTRODUCED WHEN DRAWINGS ARE REPRODUCED BY ANY MEANS. USE THE GRAPHIC SCALE BAR TO DETERMINE THE ACTUAL SCALE.

JOB NO.: DESIGN BY: DRAWN BY:

DATE: 6/18/2025

SCALE: 1/4" = 1'-0" U.N.O.

GENERAL ELECTRICAL NOTES

ALL SYMBOLS SHOW THE DESIRED LOCATIONS AND WILL BE FINALIZED DURING THE WALK-THROUGH WITH THE ELECTRICIAN. ADDITIONAL LOCATIONS MAY BE REQUIRED BY CODE.

VERIFY AND COORDINATE ALL POWER REQUIREMENTS FOR EQUIPMENT AND APPLIANCES WITH OWNER AND

VAC AT KITCHEN ISLAND AND CEILING MOUNTED VACUUM IN BETWEEN GARAGE BAYS PROVIDE IN LINE DAMPERS FOR EXHAUST FANS. TO BE PLASTIC W/ RUBBER GASKETS

OVERHEAD DOOR RECEPTICALS IN GARAGE SHALL HAVE GROUND FAULT INTERUPT PROTECTION.

PLACE TAMPER RESISTANT RECEPTICALS WHERE REQUIRED AND IN COMPLIANCE WITH 2021 IRC E 4002.14

PLACE ARC FAULT RECEPTICALS WHERE REQIRED AND IN COMPLIANCE WITH 2021 IRC E3 209.16

EXHAUST FANS 110 CFM MIN. VENTED TO OUTSIDE.

ARCHITECT
VERIFY WITH OWNER ALL LOCATIONS FOR CABLE, INTERNET, AND PHONE LOCATIONS.
PROVIDE SMOKE AND CARBON MONOXIDE DETECTORS AS SELECTED BY OWNER. PROVIDE ALLOWANCE FOR WIFI ACCESS POINTS, CAMERAS, AND SMOKE DETECTORS.
COORDINATE ALL LANDSCAPE AND EXTERIOR LIGHTING WITH THE LANDSCAPE ARCHITECT AND CONTRACTOR.
PROVIDE ALLOWANCE FOR SECURITY AND ALARM SYSTEM AND WIRING AS SELECTED BY OWNER.
PROVIDE BUILT IN LIGHTING IN THE MASTER CLOSET CABINETRY
PROVIDE CENTRAL VACULUM. VERIEX DISTANCES OF VACUUM LOCATIONS WITH MANUFACTURER. PROVIDE CABINET

PROVIDE CENTRAL VACUUM. VERIFY DISTANCES OF VACUUM LOCATIONS WITH MANUFACTURER. PROVIDE CABINET

E4203.1.3 NOT LESS THAN ONE 125 VOLT, 15 OR 20 AMPERE RECEPTICAL SUPPLIED BY A GENERAL-PURPOSE BRANCH CIRCUIT SHALL BE LOCATED NOT LESS THAN 6 FEET FROM AND NOT MORE THAN 20 FEET FROM THE INSIDE WALL OF PERMANENTLY INSTALLED POOLS AND OUTDOOR SPAS AND HOT TUBS. THIS RECEPTICAL SHALL BE LOCATED NOT MORE THAN 6 FEET, 6 INCHES ABOVE THE FLOOR, PLATFORM OR GRADE LEVEL SERVING THE POOL, SPA OR HOT TUB. 680.22(A)(1)
E3901.7 OUTDOOR OUTLETS. NOT LESS THAN ONE RECEPTICAL OUTLET THAT IS READILY ACCESSIBLE FROM GRADE
LEVEL AND LOCATED NOT MORE THAN 6'-6" ABOVE GRADE, SHALL BE INSTALLED OUTDOORS AT THE FRONT AND BACK

OF EACH DWELLING UNIT HAVING DIRECT ACCESS TO GRADE LEVEL. BALCONIES, DECKS AND PORCHES THAT ARE ACCESSIBLE FROM INSIDE WITHEN 4" HORIZONTALLY OF THE DWELLING UNIT SHALL HAVE AT LEAST ONE RECEPTICAL OUTLET ACCESSIBLE FROM THE BALCONY, DECK OR PORCH. THE RECEPTICAL SHALL BE LOCATED NOT MORE THAN 6'-6" ABOVE THE BALCONY, DECK OR PORCH SURFACE. 210.52(E)

ALL EXHAUST FANS


ARCHITECT

ALL SWITCHES FOR RECESSED LIGHTS AND SURFACE MOUNTED TO HAVE DIMMER CONTROLS. TIMER SWITCHING FOR

FIRST FLOOR -ECTRICAL PLA

\P	DUPLEX RECEPTICAL		RECEPTICAL
	AT 12' A.F.F. DUPLEX RECEPTICAL	"	220 VOLT SINGLE RECEPTICAL
P _B	IN BASEBOARD DUPLEX RECEPTICAL	φ	DEDICATED SINGLE RECEPTICAL
P c	ABOVE COUNTER	φ	DEDICATED SWITCHED
P GFI	DUPLEX RECEPTICAL GROUND FAULT	(i) Luc	RECEPTICAL UNDER COUNTER
⊕ C GFI	DUPLEX RECEPTICAL ABOVE COUNTER/GFI	Ø	DUPLEX RECEPTICAL ARC FAULT
•	DUPLEX RECEPTICAL HALF SWITCHED	7	DUPLEX RECEPT. ARC FAULT 1/2 SWITCHED
₩P GFI	DUPLEX RECEPTICAL WATER PROOF GFI	JB	JUNCTION BOX
₩UC	DUPLEX RECEPTICAL UNDER COUNTER	FB	FAN BOX
₩	QUADPLEX RECEPTICAL WATER PROOF GFI	Д	ELECTRICAL METER
•	DUPLEX RECEPTICAL WATER PROOF GFI	ㅁ	SWITCH DISCONNECT
(i) # ^A	DUPLEX RECEPTICAL ABOVE		BREAKER PANEL
\$	SWITCH SINGLE POLE		FLOURESENT LIGHT FIXTURE
\$	SWITCH 3 WAY		FLOURESENT LIGHT STRIP FIXTURE
\$_4	SWITCH 4 WAY		INCANDESCENT LIGHT CEILING MOUNT
\$_	SWITCH RHIOSTAT		INCANDESCENT LIGHT WALL MOUNT
\$	SWITCH DIMMER		RECESSED LIGHT FIXTURE
\$ _K	SWITCH KEYED		RECESSED LIGHT VAPOR PROOF
P	SWITCH PUSH BOTTON	©	RECESSED LIGHT FIXTURE, DIRECTIONAL
K	SECURITY KEYPAD	TR	LOW VOLTAGE TRANSFORMER
	DOOR CHIME	464	SECURITY LIGHT
DR)	LOW VOLTAGE DOOR RELEASE	狐	STEP LIGHT OR POST LIGHT, WATERPROOF
5D	SMOKE AND CARBON MONOXIDE DETECTOR	\otimes	SPEAKER IN CEILING
SD	SMOKE DETECTOR LOW VOLTAGE	\bigcirc	VOLUME CONTROL
©M)	CARBON MONOXIDE DETECTOR	TV	TELEVISION JACK PREWIRE
EF)	EXHAUST FAN	\	TELEPHONE OUTLET 12" A.F.F.
1	EXHAUST FAN / LIGHT COMBO	8	TELEPHONE OUTLET FLUSH IN FLOOR
X	CEILING FAN		PHONE / DATA OUTLET
P	HVAC THERMOSTAT	нв †	HOSE BIB

CENTRAL VACUME INLET

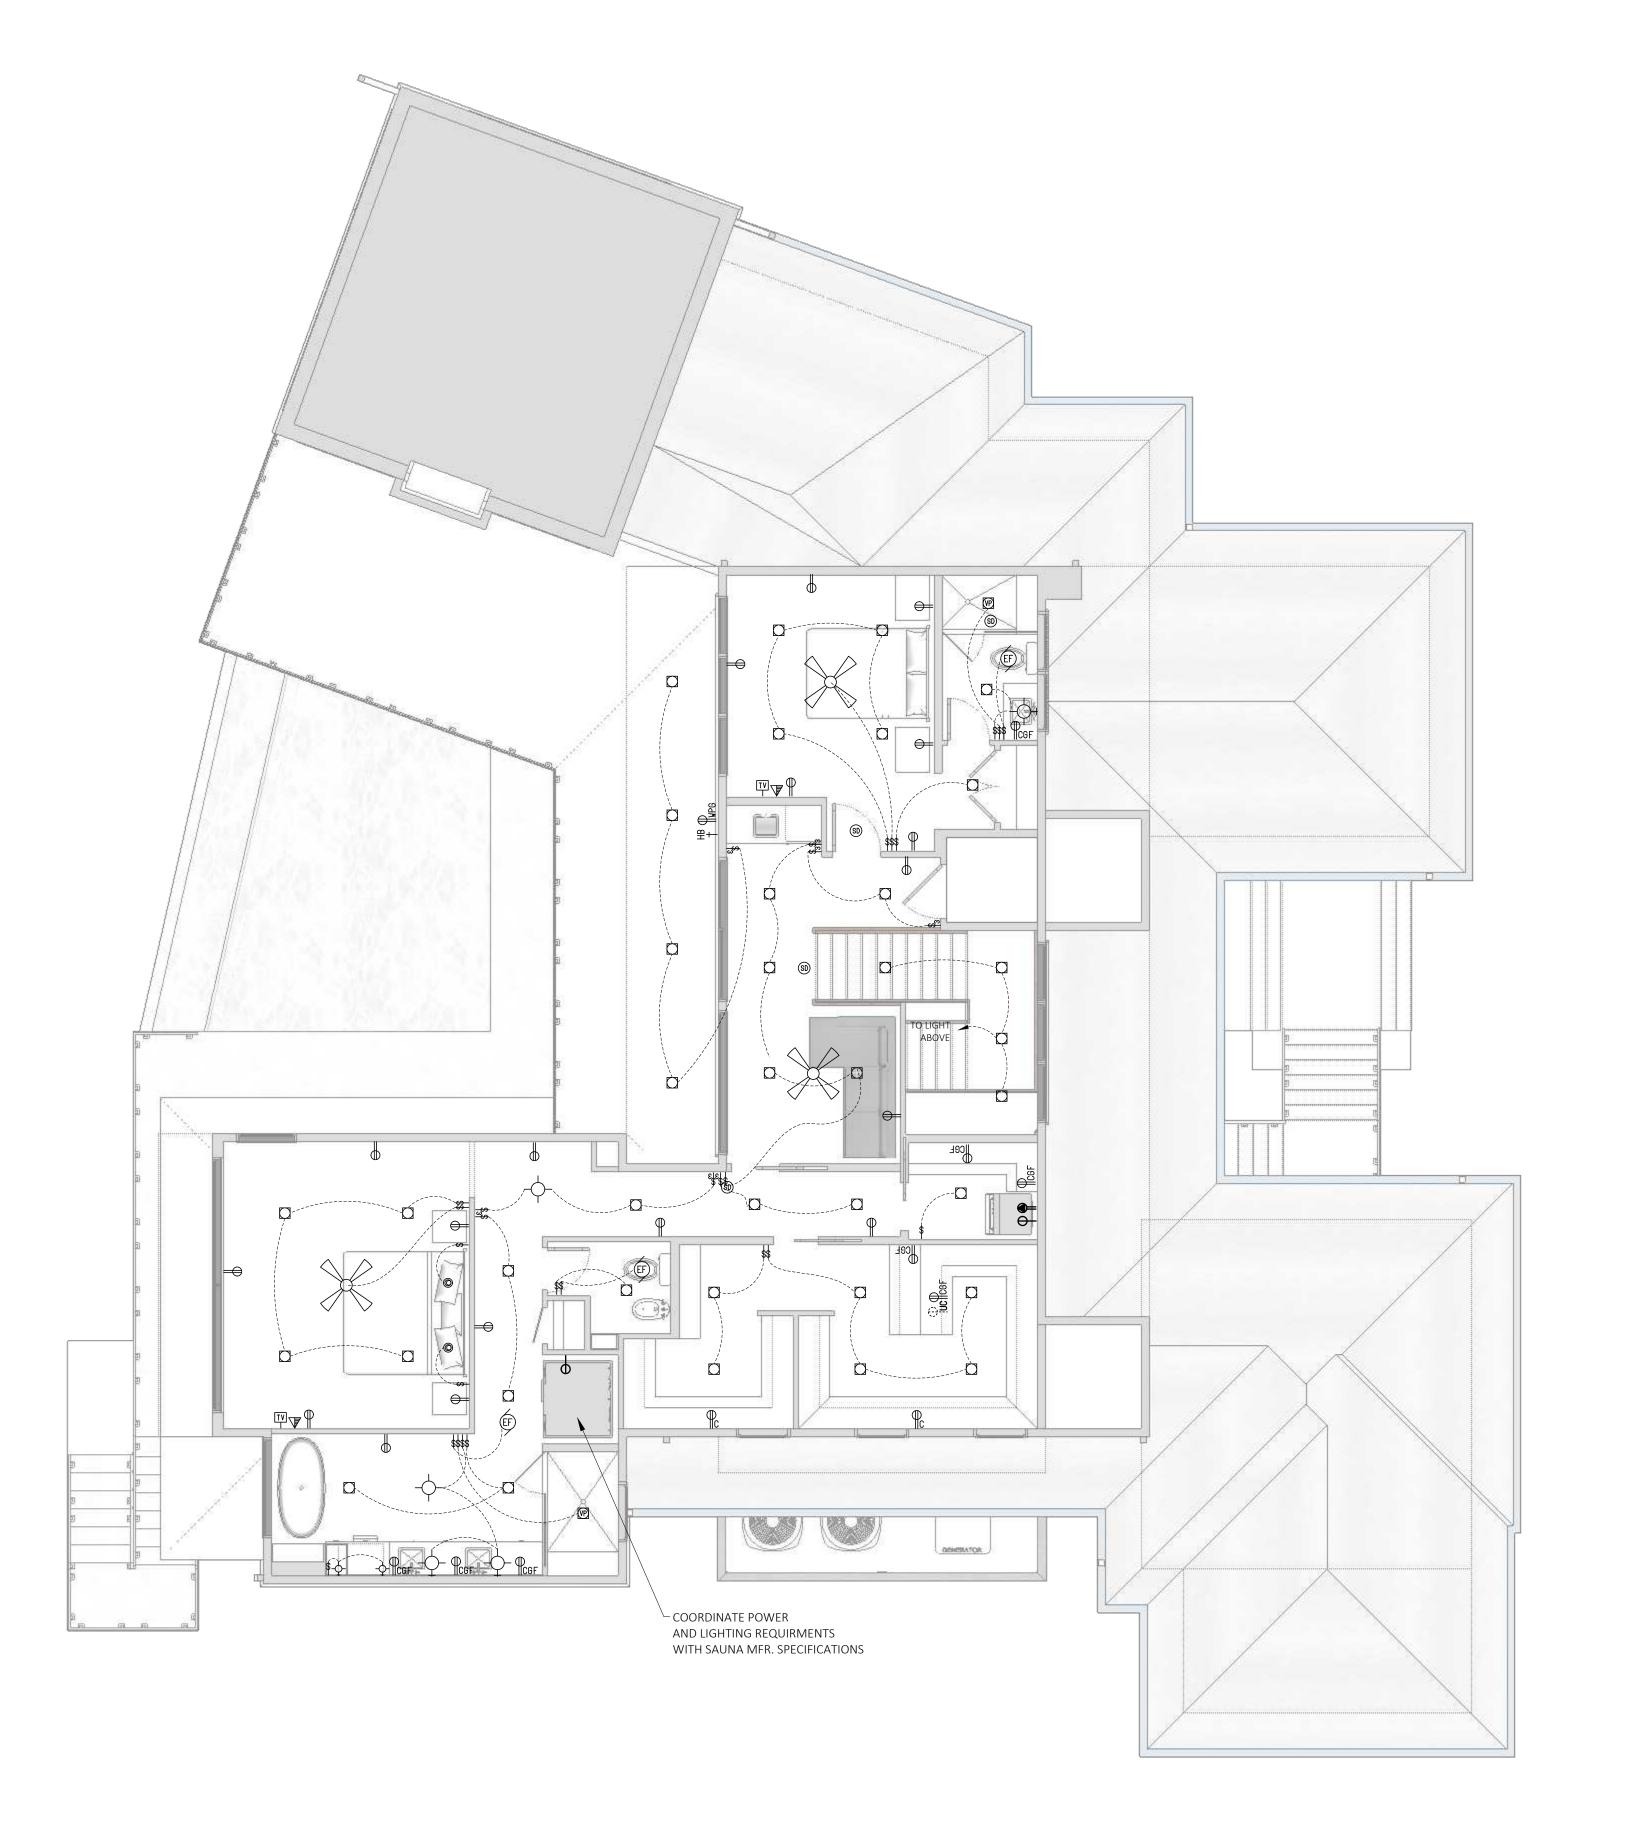





COPYRIGHT 2024 ALL RIGHTS COPYRIGHT 2024 ALL RIGHTS
RESERVED
IT IS A VIOLATION OF LAW FOR ANY
PERSON, UNLESS ACTING UNDER THE
DIRECTION OF DLB CUSTOM HOME
DESIGN, TO ALTER THIS DOCUMENT.
PRINTED OR ELECTRONIC DRAWINGS
AND DOCUMENTATION MAY NOT BE
REPRODUCED IN ANY FORM WITHOUT
WRITTEN PERMISSION. THIS DRAWING WAS PREPARED AT THE SCALE INDICATED.
INACCURACIES IN THE STATED SCALE MAY BE INTRODUCED WHEN DRAWINGS ARE REPRODUCED BY ANY MEANS. USE THE GRAPHIC SCALE BAR TO DETERMINE THE ACTUAL SCALE.

JOB NO.: DESIGN BY: DRAWN BY:

DATE: 6/18/2025 SCALE: 1/4" = 1'-0" U.N.O.

GENERAL ELECTRICAL NOTES

ALL SYMBOLS SHOW THE DESIRED LOCATIONS AND WILL BE FINALIZED DURING THE WALK-THROUGH WITH THE

VERIFY AND COORDINATE ALL POWER REQUIREMENTS FOR EQUIPMENT AND APPLIANCES WITH OWNER AND

VERIFY WITH OWNER ALL LOCATIONS FOR CABLE, INTERNET, AND PHONE LOCATIONS.
PROVIDE SMOKE AND CARBON MONOXIDE DETECTORS AS SELECTED BY OWNER. PROVIDE ALLOWANCE FOR WIFI ACCESS POINTS, CAMERAS, AND SMOKE DETECTORS.

PROVIDE CENTRAL VACUUM. VERIFY DISTANCES OF VACUUM LOCATIONS WITH MANUFACTURER. PROVIDE CABINET

E4203.1.3 NOT LESS THAN ONE 125 VOLT, 15 OR 20 AMPERE RECEPTICAL SUPPLIED BY A GENERAL-PURPOSE BRANCH CIRCUIT SHALL BE LOCATED NOT LESS THAN 6 FEET FROM AND NOT MORE THAN 20 FEET FROM THE INSIDE WALL OF PERMANENTLY INSTALLED POOLS AND OUTDOOR SPAS AND HOT TUBS. THIS RECEPTICAL SHALL BE LOCATED NOT MORE THAN 6 FEET, 6 INCHES ABOVE THE FLOOR, PLATFORM OR GRADE LEVEL SERVING THE POOL, SPA OR HOT TUB. 680.22(A)(1)
E3901.7 OUTDOOR OUTLETS. NOT LESS THAN ONE RECEPTICAL OUTLET THAT IS READILY ACCESSIBLE FROM GRADE
LEVEL AND LOCATED NOT MORE THAN 6'-6" ABOVE GRADE, SHALL BE INSTALLED OUTDOORS AT THE FRONT AND BACK

OF EACH DWELLING UNIT HAVING DIRECT ACCESS TO GRADE LEVEL. BALCONIES, DECKS AND PORCHES THAT ARE ACCESSIBLE FROM INSIDE WITHEN 4" HORIZONTALLY OF THE DWELLING UNIT SHALL HAVE AT LEAST ONE RECEPTICAL OUTLET ACCESSIBLE FROM THE BALCONY, DECK OR PORCH. THE RECEPTICAL SHALL BE LOCATED NOT MORE THAN 6'-6" ABOVE THE BALCONY, DECK OR PORCH SURFACE. 210.52(E)

COORDINATE ALL LANDSCAPE AND EXTERIOR LIGHTING WITH THE LANDSCAPE ARCHITECT AND CONTRACTOR. PROVIDE ALLOWANCE FOR SECURITY AND ALARM SYSTEM AND WIRING AS SELECTED BY OWNER.

ALL SWITCHES FOR RECESSED LIGHTS AND SURFACE MOUNTED TO HAVE DIMMER CONTROLS. TIMER SWITCHING FOR

ELECTRICIAN. ADDITIONAL LOCATIONS MAY BE REQUIRED BY CODE.

PROVIDE BUILT IN LIGHTING IN THE MASTER CLOSET CABINETRY

EXHAUST FANS 110 CFM MIN. VENTED TO OUTSIDE.

VAC AT KITCHEN ISLAND AND CEILING MOUNTED VACUUM IN BETWEEN GARAGE BAYS PROVIDE IN LINE DAMPERS FOR EXHAUST FANS. TO BE PLASTIC W/ RUBBER GASKETS

OVERHEAD DOOR RECEPTICALS IN GARAGE SHALL HAVE GROUND FAULT INTERUPT PROTECTION. PLACE ARC FAULT RECEPTICALS WHERE REQIRED AND IN COMPLIANCE WITH 2021 IRC E3 209.16

PLACE TAMPER RESISTANT RECEPTICALS WHERE REQUIRED AND IN COMPLIANCE WITH 2021 IRC E 4002.14

ALL EXHAUST FANS

ARCHITECT

FLOOR AL PLAN

SECOND F