	ARCHITECTURA	L AB	BREVIATIONS
A.F.F.	ABOVE FINISHED FLOOR	GFI	GROUND FAULT INTERRUPTER
A.F.G.	ABOVE FINISHED GRADE AIR CONDITIONING	GLB GYP. BD.	GLUE LAMINATED BEAM GYPSUM BOARD
ABV.	ABOVE	H.B.	HOSE BIBB
ACOU.	ACOUSTIC	HDBD.	HARDBOARD
ADD.	ADDITION or ADDENDUM	HGT.	HEIGHT
AG AHU	ABOVE GRADE AIR HANDLER UNIT	HOR.	HORIZONTAL "HEATING, VENTILATING & AIR CONDITIONING
	. ALUMINUM	HW	HOT WATER
ALT.	ALTERNATE	HYD.	HYDRAULIC
ASPH.	ASPHALT	I.F.	INSIDE FACE
AVG AWG	AVERAGE AMERICAN WIRE GAUGE	INCL.	"INCLUDE, INCLUSIVE" INSULATION
4	ANGLE	INT.	INTERIOR
B.M.	BENCH MARK	JST.	JOIST
B.N.	BOUNDARY NAILING	KD	KILN DRIED
B.O. B.O.F.	BOTTOM OF BOTTOM OF FOOTING	L.E.D.	LIGHT EMITTING DIODE LAMINATE
B.U.	BUILT UP	LT.	LIGHT
BD.	BOARD	LTG.	LIGHTING
BLDG	BUILDING	LVL	LAMINATED VENEER LUMBER
BLKG.	BLOCK BLOCKING	M.O.	MASONRY OPENING MASONRY
BM.	BEAM	MAT'L	MATERIAL
BRG.	BEARING	MAX.	MAXIMUM
C.D.	CONSTRUCTION DOCUMENTS	MECH.	MECHANICAL
C.J.	CONTROL JOINT CLEAN OUT	MFR.	MANUFACTURER MINIMUM
C.T.	CERAMIC TILE	MISC.	MISCELLANEOUS
CAB	CABINET	MOD	MODULAR
CEM.	CEMENT	MTL.	METAL
CL or Q_ CLG.	CENTERLINE CEILING	MUL N.I.C.	MULLION NOT IN CONTRACT
CLG.	CAULKING	N.T.S.	NOT TO SCALE
CLST	CLOSET	NCM	NON-CORROSIVE METAL
CLR.	CLEAR	NFC	NOT FOR CONSTRUCTION
CMU CNTRD.	CONCRETE MASONRY UNIT CENTERED	NO.	NUMBER NOMINAL
COL.	COLUMN	O.C.	ON CENTER
CONC.	CONCRETE	O.D.	OUTSIDE DIAMETER
CONST.	CONSTRUCTION	O.H.	OVER HANG
CONT.	CONTRACTOR	OH	OVER HEAD
CONTR.	CONTRACTOR COPPER	OPNG. P.L. or P	OPENING PROPERTY LINE
D/W	DISHWASHER	P.LAM.	PLASTIC LAMINATE
DBL.	DOUBLE	PERF.	PERFORATED
DEMO	DEMOLITION	PERP. olr	PERPENDICULAR
DIA. or Ø DIAG.	DIAMETER DIAGONAL	PLUMB. PLYWD.	PLUMBING PLYWOOD
DIM.	DIMENSION	PREFAB.	PREFABRICATED
DN.	DOWN	PTN.	PARTITION
EA.	EACH	PVC	POLYVINYLCLORIDE
ELECT.	ELEVATION "ELECTRIC, ELECTRICAL"	PWR. QTY.	POWER QUANTITY
ELEV.	ELEVATOR	R	RADIUS
EQ.	EQUAL	R.D.L.	ROOF DRAIN LEADER
EQUIP.	EQUIPMENT	R.D.O.	ROOF DRAIN OVERFLOW
EST. EXH.	ESTIMATE EXHAUST	R.O. REF	ROUGH OPENING REFRIGERATOR
EXIST. or E	EXISTING	REF.	REFERENCE
EXT.	EXTERIOR	REINF.	REINFORCED
F.A.	FIRE ALARM	REQ'D.	REQUIRED
F.E. F.O.	FIRE EXTINGUISHER FACE OF	RET.	RETURN REVISION
F/G	FIBERGLASS	RM	ROOM
FAB.	FABRICATE	S.C.	SOLID CORE
FDN.	FOUNDATION	S/L	SKYLIGHT
FIN.	FINISH	S/S SC	STAINLESS STEEL SELF CLOSING
FLG.	FLOORING	SCHED.	SCHEDULE
FTG.	FOOTING	SECT.	SECTION
FURN.	FURNISH	SHT'G.	SHEATHING
GA. GALV.	GAUGE GALVANIZED	SIM. SPECS	SIMILAR SPECIFICATIONS
GALV.	GROUND FAULT CIRCUIT INTERRUPTER	STC	SOUND TRANSMISSION CLASS
STD.	STANDARD	THRU	THROUGH
STL.	STEEL	TLT.	TOILET
T & G T.O.	TONGUE AND GROOVE TOP OF	TYP.	TYPICAL
T.O.B.	TOP OF BEAM	UNF. V.B.	UNFINISHED VAPOR BARRIER
T.O.C.	TOP OF CURB	V.I.F.	VERIFY IN FIELD
T.O.F.	TOP OF FOOTING	VERT.	VERTICAL
T.O.J. T.O.M.	TOP OF MASONRY	WCT	WAINSCOT WEATHER PROOF
T.O.S.	TOP OF MASONRY TOP OF SLAB	WP WT.	WEATHER PROOF WEIGHT
T.O.W.	TOP OF WALL	W/	WITH
TH.	THRESHOLD	W/O	WITHOUT
THK	THICK	WD	WOOD



SHEET	DESCRIPTION
1	SURVEY
A-0	COVER SHEET
A-0.1	SPECIFICATIONS
A-0.1	SPECIFICATIONS
A-1	ARCHITECTURAL SITE PLAN
<u>^ 1</u>	ARCHITECTORAL SITE I LAW
A-2.0	GROUND FLOOR PLAN
A-2.1	FIRST FLOOR PLAN
A-2.1.1	FIRST FLOOR REFLECTED CEILING PLAN
A-2.2	SECOND FLOOR PLAN
A-2.2.1	SECOND FLOOR REFLECTED CEILING PLAN
A-2.3	ROOF PLAN
A-2.4	DOOR, WINDOW AND ROOM FINISH SCHEDULES
	,
A-3.1	FRONT ELEVATION
A-3.2	BACK ELEVATION
A-3.3	LEFT ELEVATION
A-3.4	RIGHT ELEVATION
A-3.5	FRONT-LEFT PERSPECTIVE
A-3.6	BACK-RIGHT PERSPECTIVE
A-4.1	BUILDING SECTIONS AND DETAILS
A-4.2	BUILDING SECTIONS AND DETAILS
A-4.3	BUILDING SECTIONS AND DETAILS
A-4.4	BUILDING SECTIONS AND DETAILS
A-4.5	BUILDING SECTIONS AND DETAILS
A-4.6	BUILDING SECTIONS AND DETAILS
A-4.7	BUILDING SECTIONS AND DETAILS
Λ F O	ACCEMPLIEC
A-5.0 A-5.1	ASSEMBLIES
A-5.1 A-5.2	WALL SECTIONS AND DETAILS WALL SECTIONS AND DETAILS
A-5.2 A-5.3	WALL SECTIONS AND DETAILS WALL SECTIONS AND DETAILS
A-5.3 A-5.4	WALL SECTIONS AND DETAILS WALL SECTIONS AND DETAILS
A-5.4 A-5.5	WALL SECTIONS AND DETAILS WALL SECTIONS AND DETAILS
A-3.3	WALE SECTIONS AND DETAILS
A-6.1	INTERIOR ELEVATIONS
A-6.2	INTERIOR ELEVATIONS
, , 0,2	THE TOTAL PROPERTY OF THE PROP
E-0	GROUND FLOOR ELECTRICAL PLAN
E-1	FIRST FLOOR ELECTRICAL PLAN
E-2	SECOND FLOOR ELECTRICAL PLAN

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BRITT LAND SURVEYING, INC.

SITE ZONING INFORMATION:

CHARLESTON COUNTY, SC

3203 MARSHALL BLVD.

SULLIVANS ISLAND

LOT 1, BLOCK 16,

PROPERTY AREA:

FLOOD ZONE:

BASE FLOOD

DESIGN FLOOD

MAX. HEIGHT:

BACK SETBACK

CHARLESTON COUNTY, SC


RIGHT SETBACK

EXISTING DECK

38'-0"

BARKOWITZ RESIDENCE

3203 MARSHALL BLVD. SULLIVANS ISLAND CHARLESTON COUNTY, SC LOT 1, BLOCK 16,

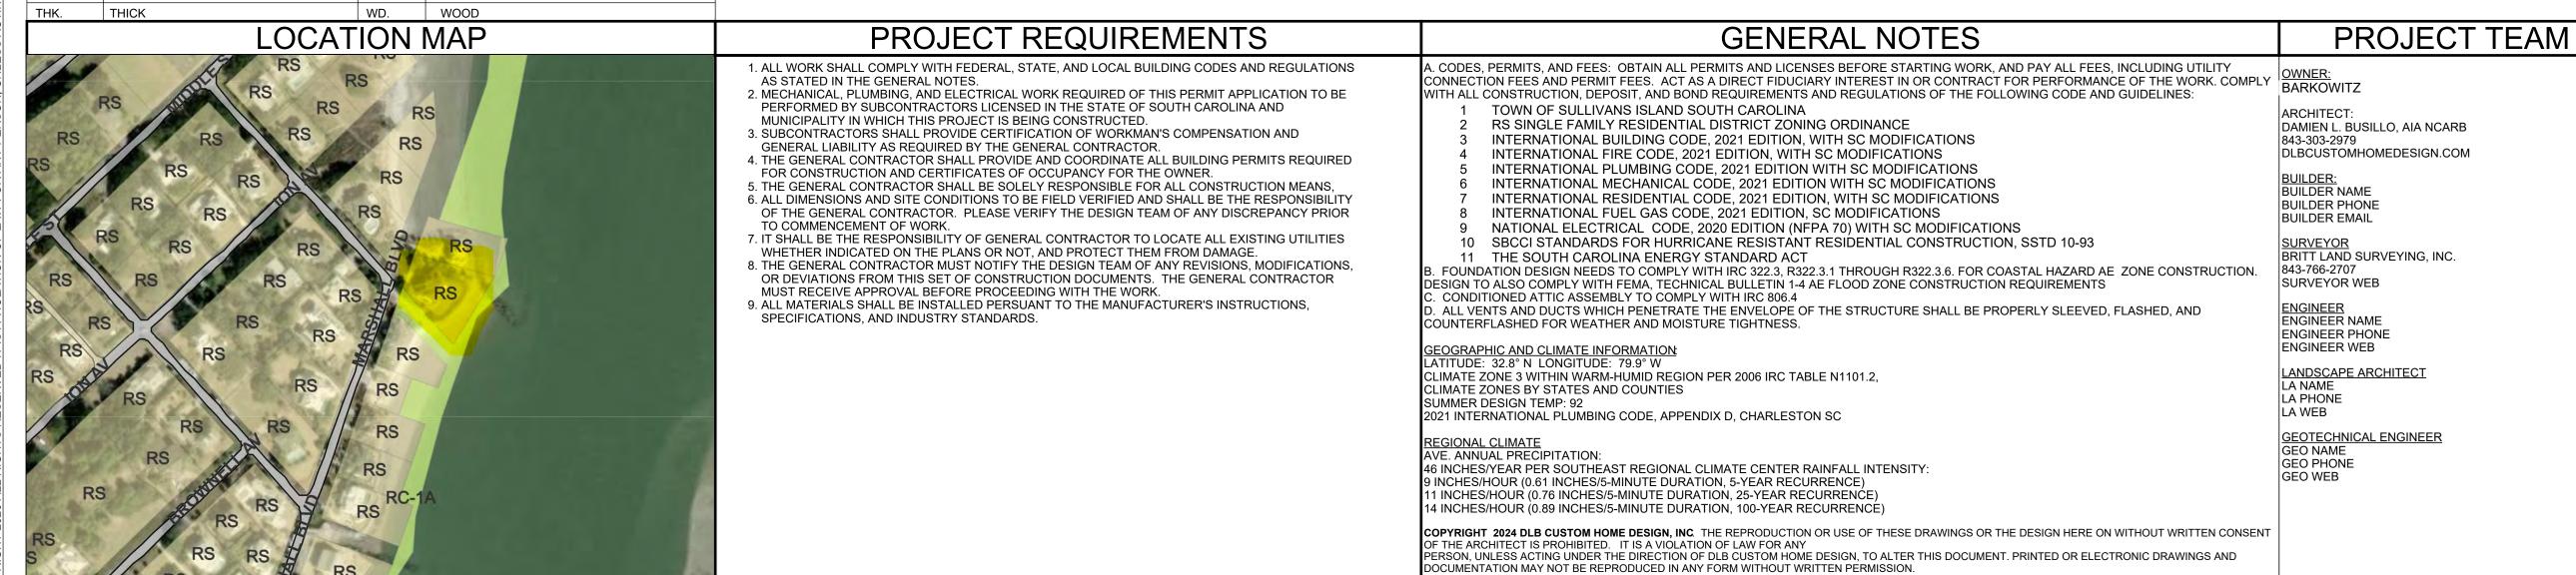


SITE INFORMATION THIS INFORMATION WAS PREPARED AND PROVIDED: THE CONSTRUCTION DOCUMENTS DESCRIBE A NEW SINGLE FAMILY HOME THAT WILL BE CONSTRUCTED IN: SHEET NO.

JOB NO.: DESIGN BY: DRAWN BY: SCALE: 1/4" = 1'-0" U.N.O.


SHE

0

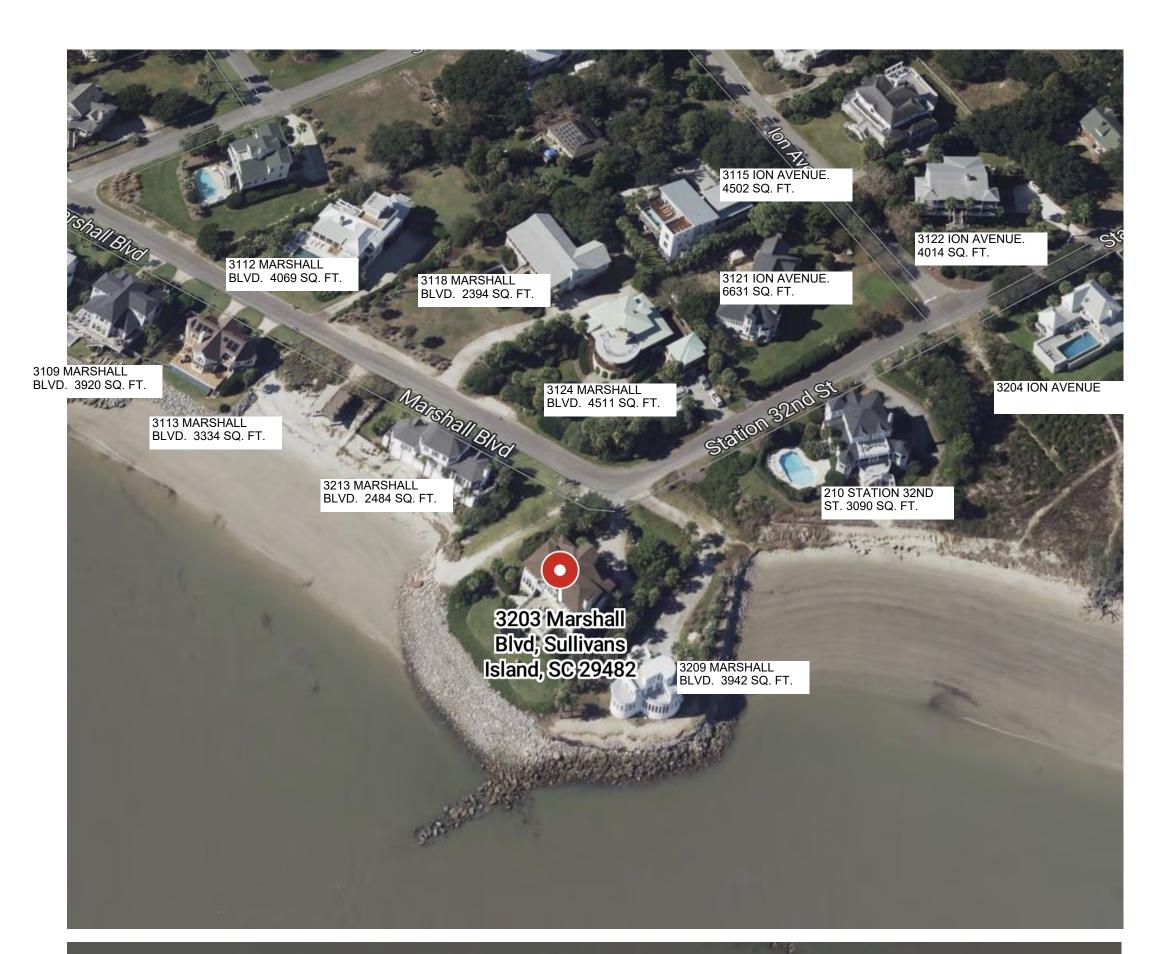



ZONING STANDARD WORKSHEET								
	ZONING ORDINANCE	ZONING STANDARD	DESIGN CONFORMS WITH STANDARD	DRB'S MAX AUTHORITY FOR RELIEF	VARIANCE REQUEST IF APPLICABLE	PERCENTAGE OF VARIANCE RELIEF REQUESTED	TOTAL SQUARE FOOTAGE ALLOWED PER ZONING CODE /PERCENTAGE OF RELIEF	GENERAL NOTES
	FRONT YARD SETBACK	25'-0"		15% OR 3.75'				
	ADDITIONAL FRONT YARD SETBACK	45 DEGREES ABOVE 20'-0"		15%				
SETBACKS	SIDE YARD SETBACK	COMBINED 38.67' TOTAL; 10'-0" MINIMUM		25% FOR A TOTAL COMBINED OF 29'-0"				
	2ND STORY SIDE YARD FACADE SETBACK	2'-0" SETBACK FOR 2ND STORY WALLS WIDER THAN 10'-0"		100%				
	REAR SETBACK	EDGE OF EXISTING REAR DECK		N/A				DETERMINED BY DHEC-OCRM AND CONFIRMED BY MATT SLAGEL ON 2/14/202 THE REAR SETBACK IS A STRAIGHT LINE ON THE EDGE OF TEH EXISTING DECK A EXTENDS ON A LINEAR PATH TO THE SIDE PROPERTY LINES
	PRINCIPLE BUILDING COVERAGE	15% OF LOT AREA; 20,449 SQ.FT x 15% = 3,067 SQ. FT.	2977 S.F.	20% 613 SQ.F.T				
	IMPERVIOUS COVERAGE	30% OF LOT AREA; 20,449 SQ.FT. x 30% = 6,135 SQ. FT. 50% OF LOT TO BE NATURALLY VEGETATED		N/A				
	PRINCIPLE BUILDING SQUARE FOOTAGE	20,449 SQ.FT 5000 SQ.FT./100 X10 + 2400 SQ.F.T = 3944.9 SQ.FT. ALLOWED		15% OR 500 SQ. FT. WHICHEVER IS LESS (IN THIS CASE, 500 SQ.F.T)			4,444.9 SQ.FT. MAX ALLOWED	
	THIRD STORY	400 SQ.FT. MAX ALLOWED		15%				
DESIGN STANDARDS	PRINCIPLE BUILDING FRONT FACADE	50'-0" OF 2/3 BUILDABLE LOT WIDTH		100%				
	PRINCIPLE BUILDING SIDE FACADE	30'-0" WITHOUT ARTICULATION (INSET OF 4'-0")		100% OR 60'-0"				
	BUILDING FOUNDATION HEIGHT	6'-5" ABOVE BASE FLOOD ELEVATION (VE 12)		1'-0"	1'-0"	BFE: 12 MSL DFE 14 MSL TOP OF BLOCK AT 18.5 MSL		
	FOUNDATION ENCLOSURE			ADJUST FOR NEIGHBORHOOD COMPATIBILITY				
	ACCESSORY STRUCTURE	MAX HEIGHT IS 18'-0"						
	DETACHED DECK	144 S.F. ALLOWED	YES					

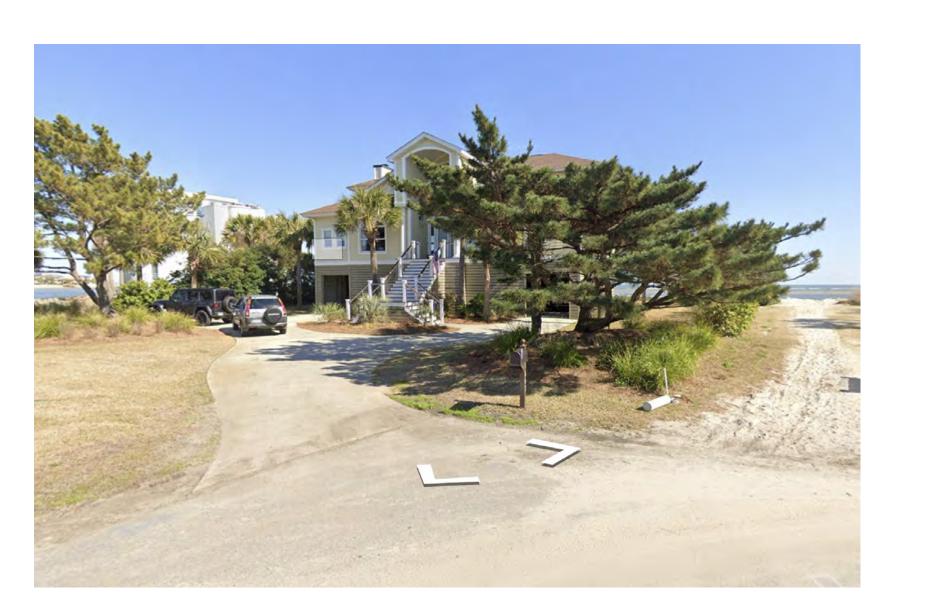









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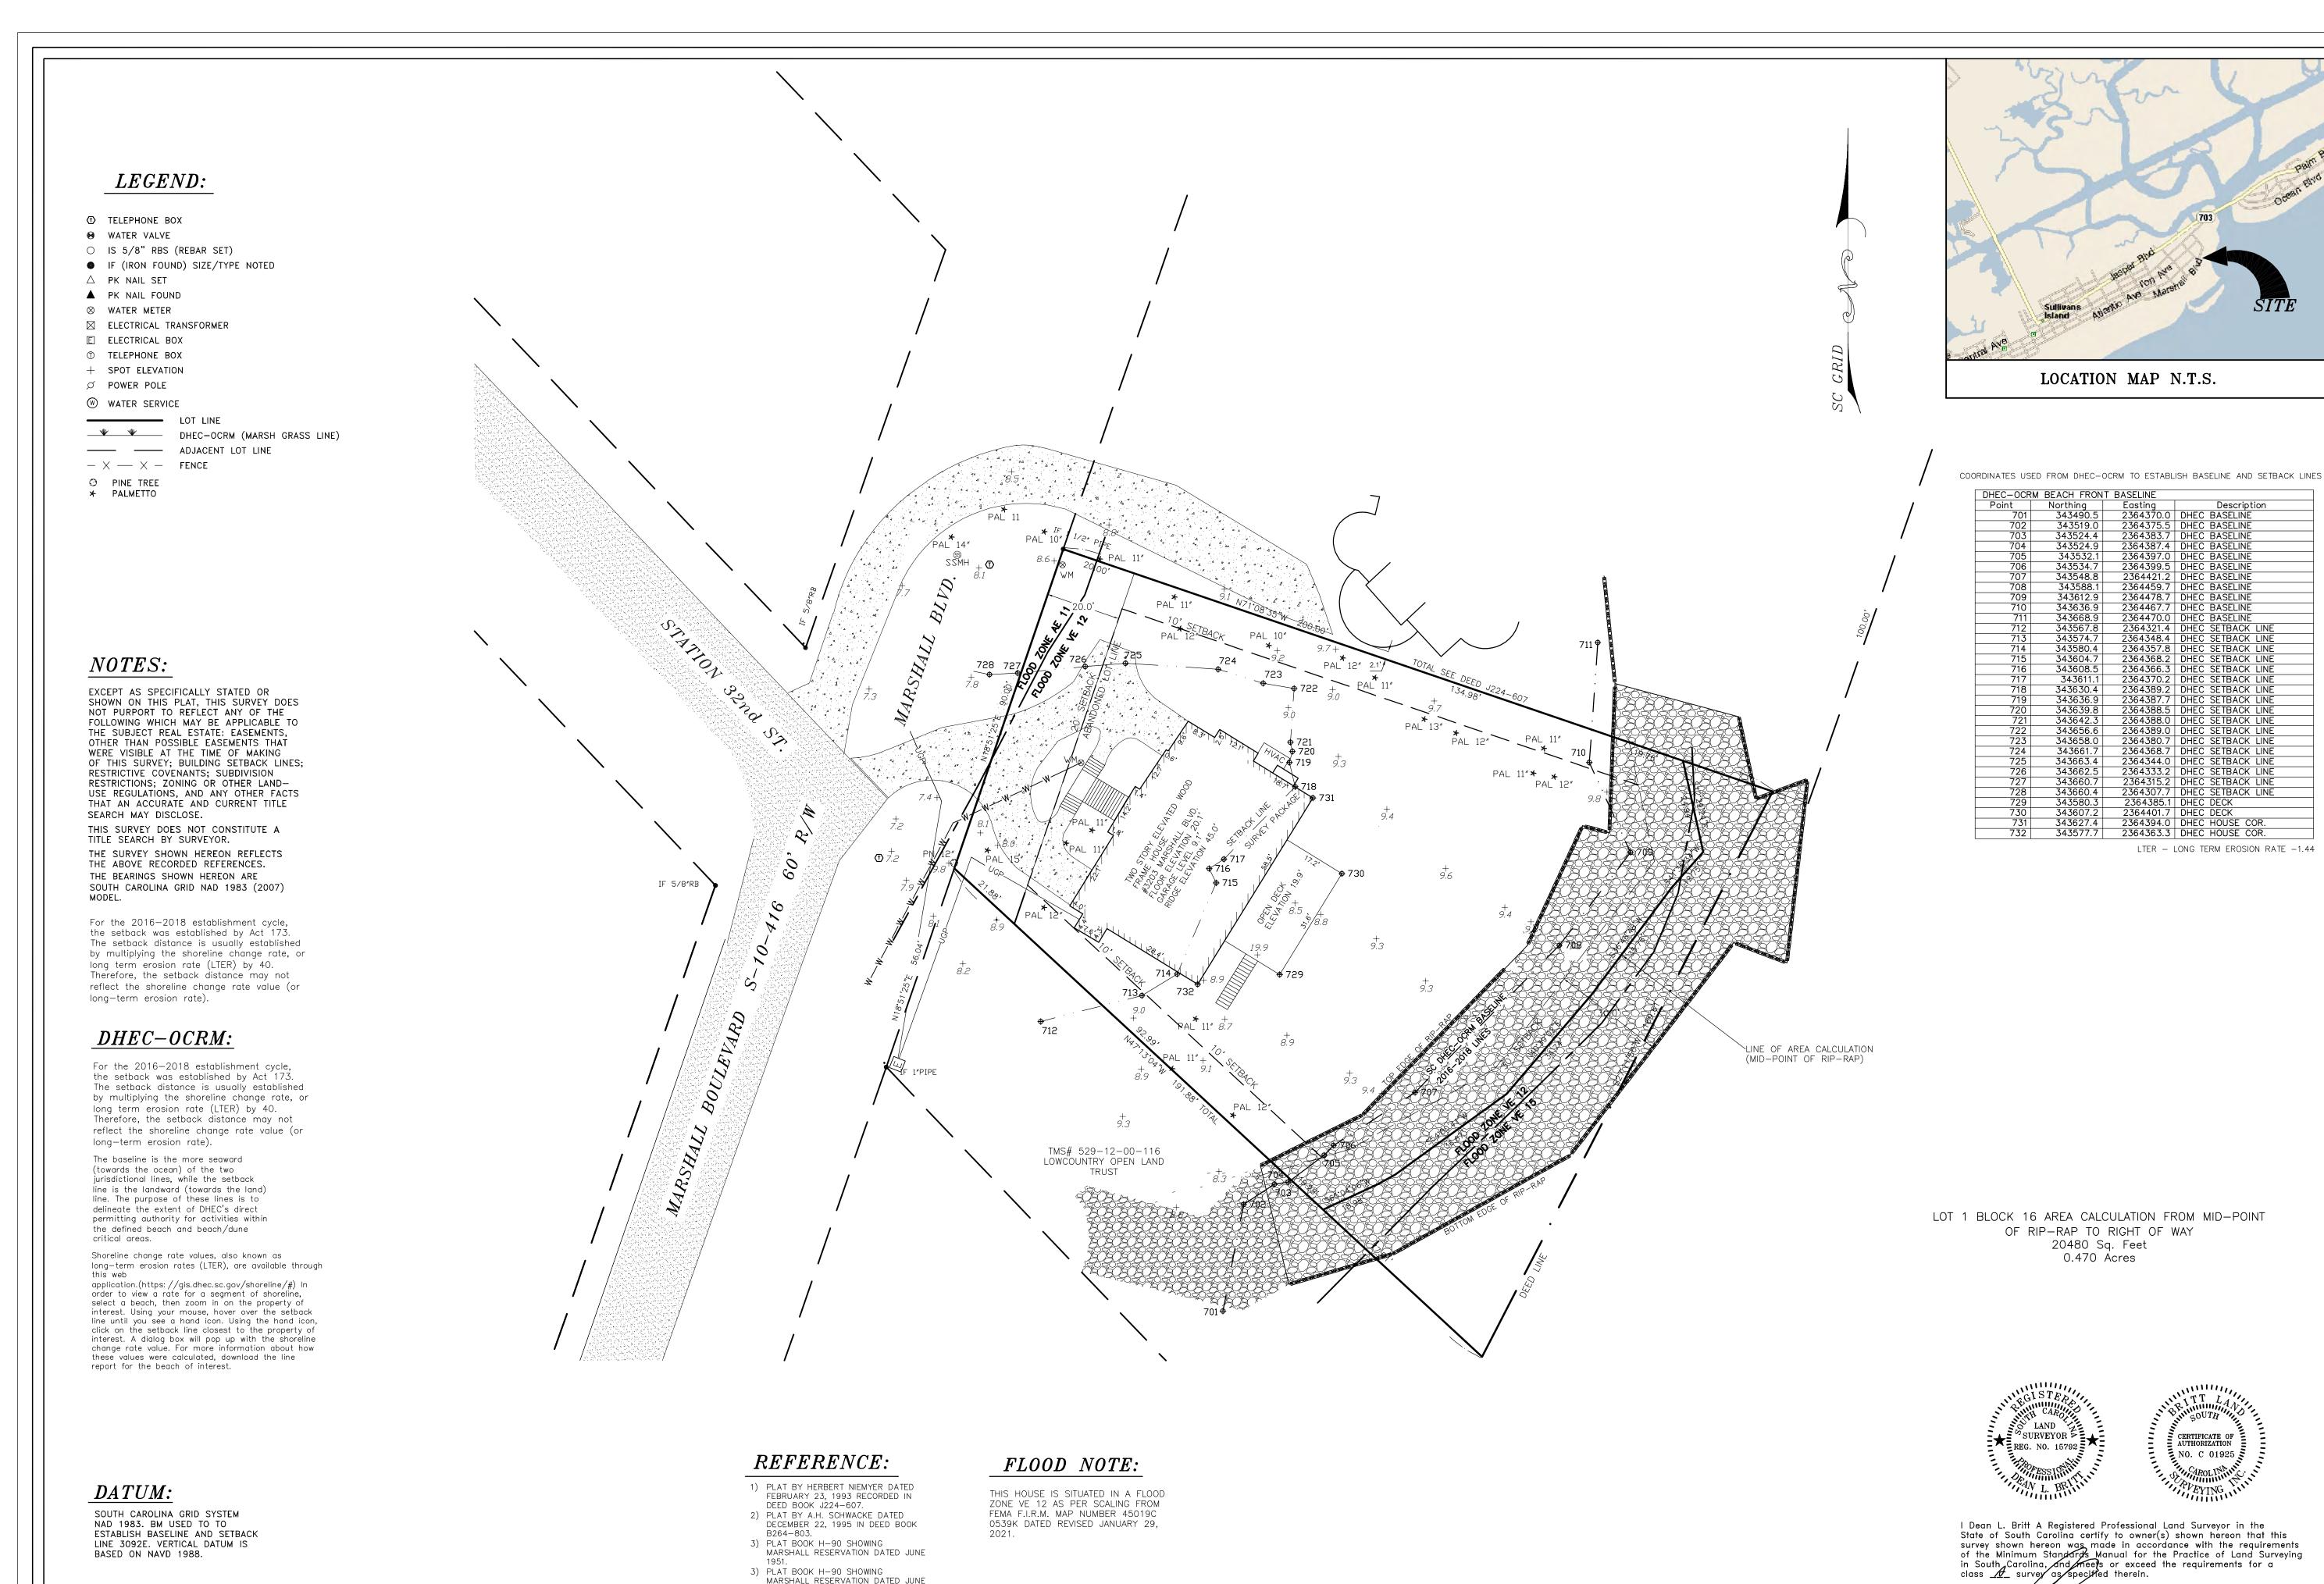
JOB NO.: DESIGN BY:

SCALE: 1/4" = 1'-0" U.N.O.

ZONING DATA & EXISTING CONDITIONS

SHEET NO.

A-0.1



3) PLAT BOOK H-90 SHOWING


MARSHALL RESERVATION DATED JUNE


4) PLAT BOOK Z-15 DATED JUNE 23,


LAND SI NX 8033; FSTON, S

Date: MARCH 06, 2024 S.C. REG. NO. 15792


DEAN L. BRITT PLS

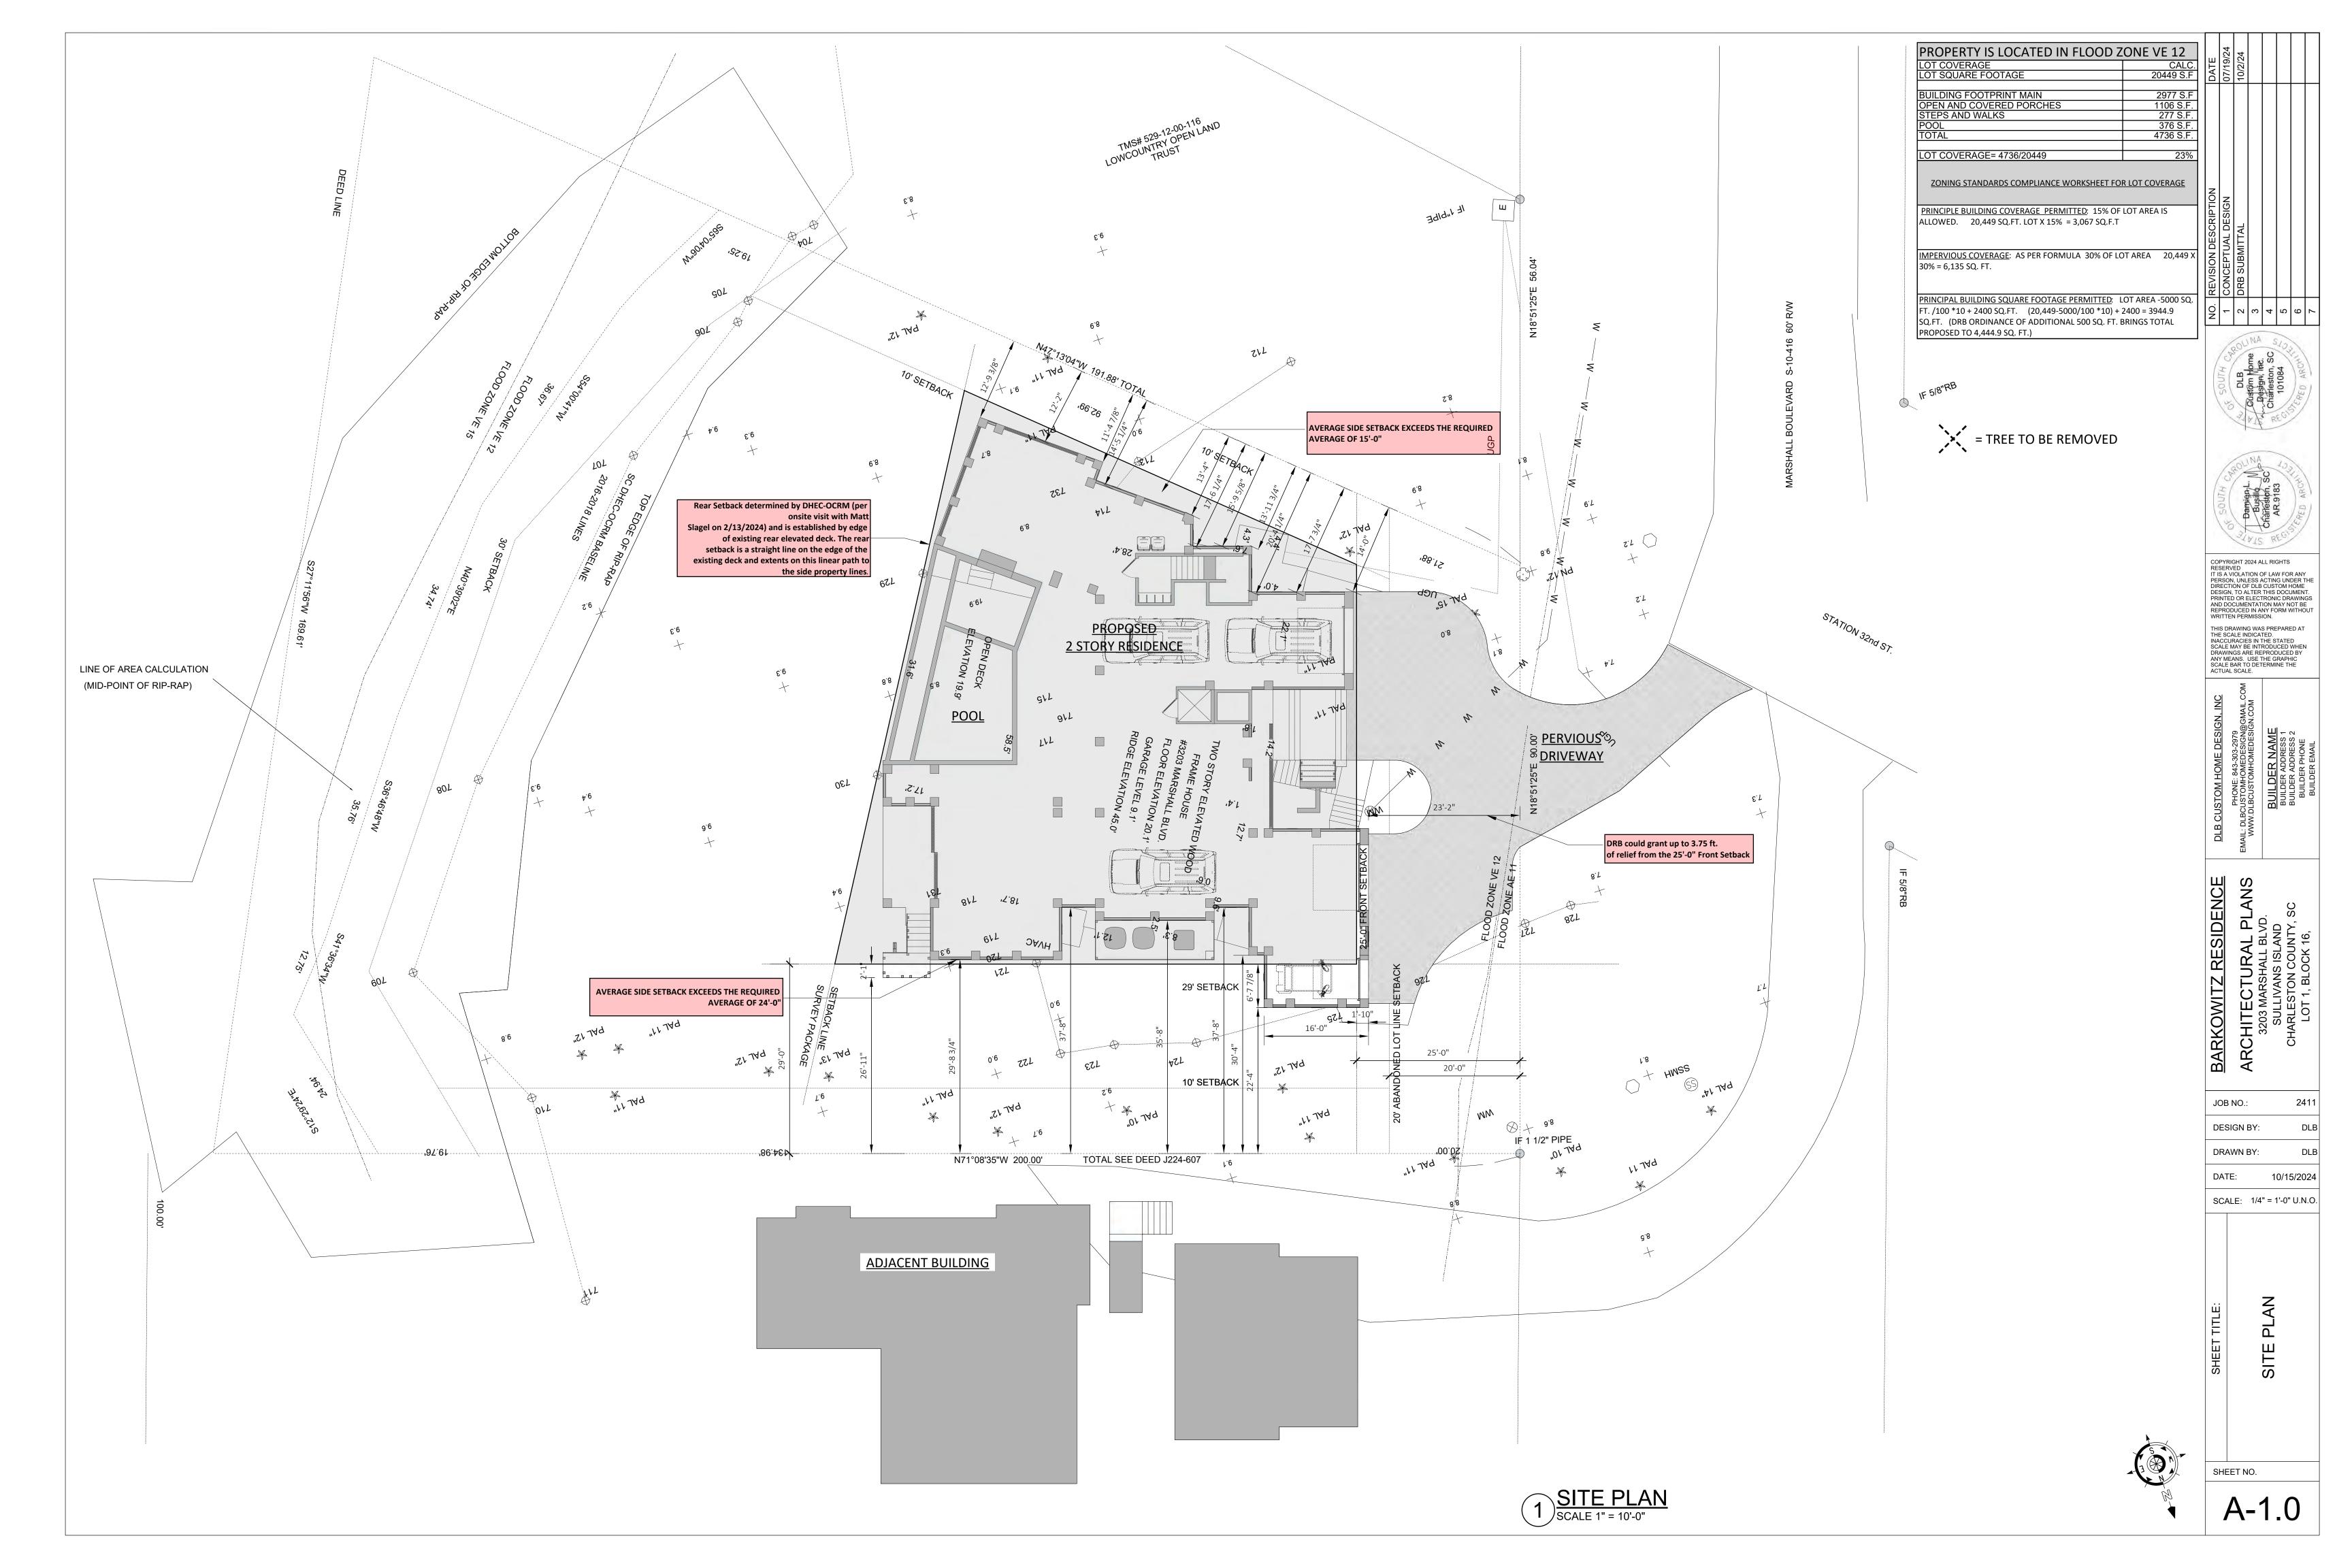


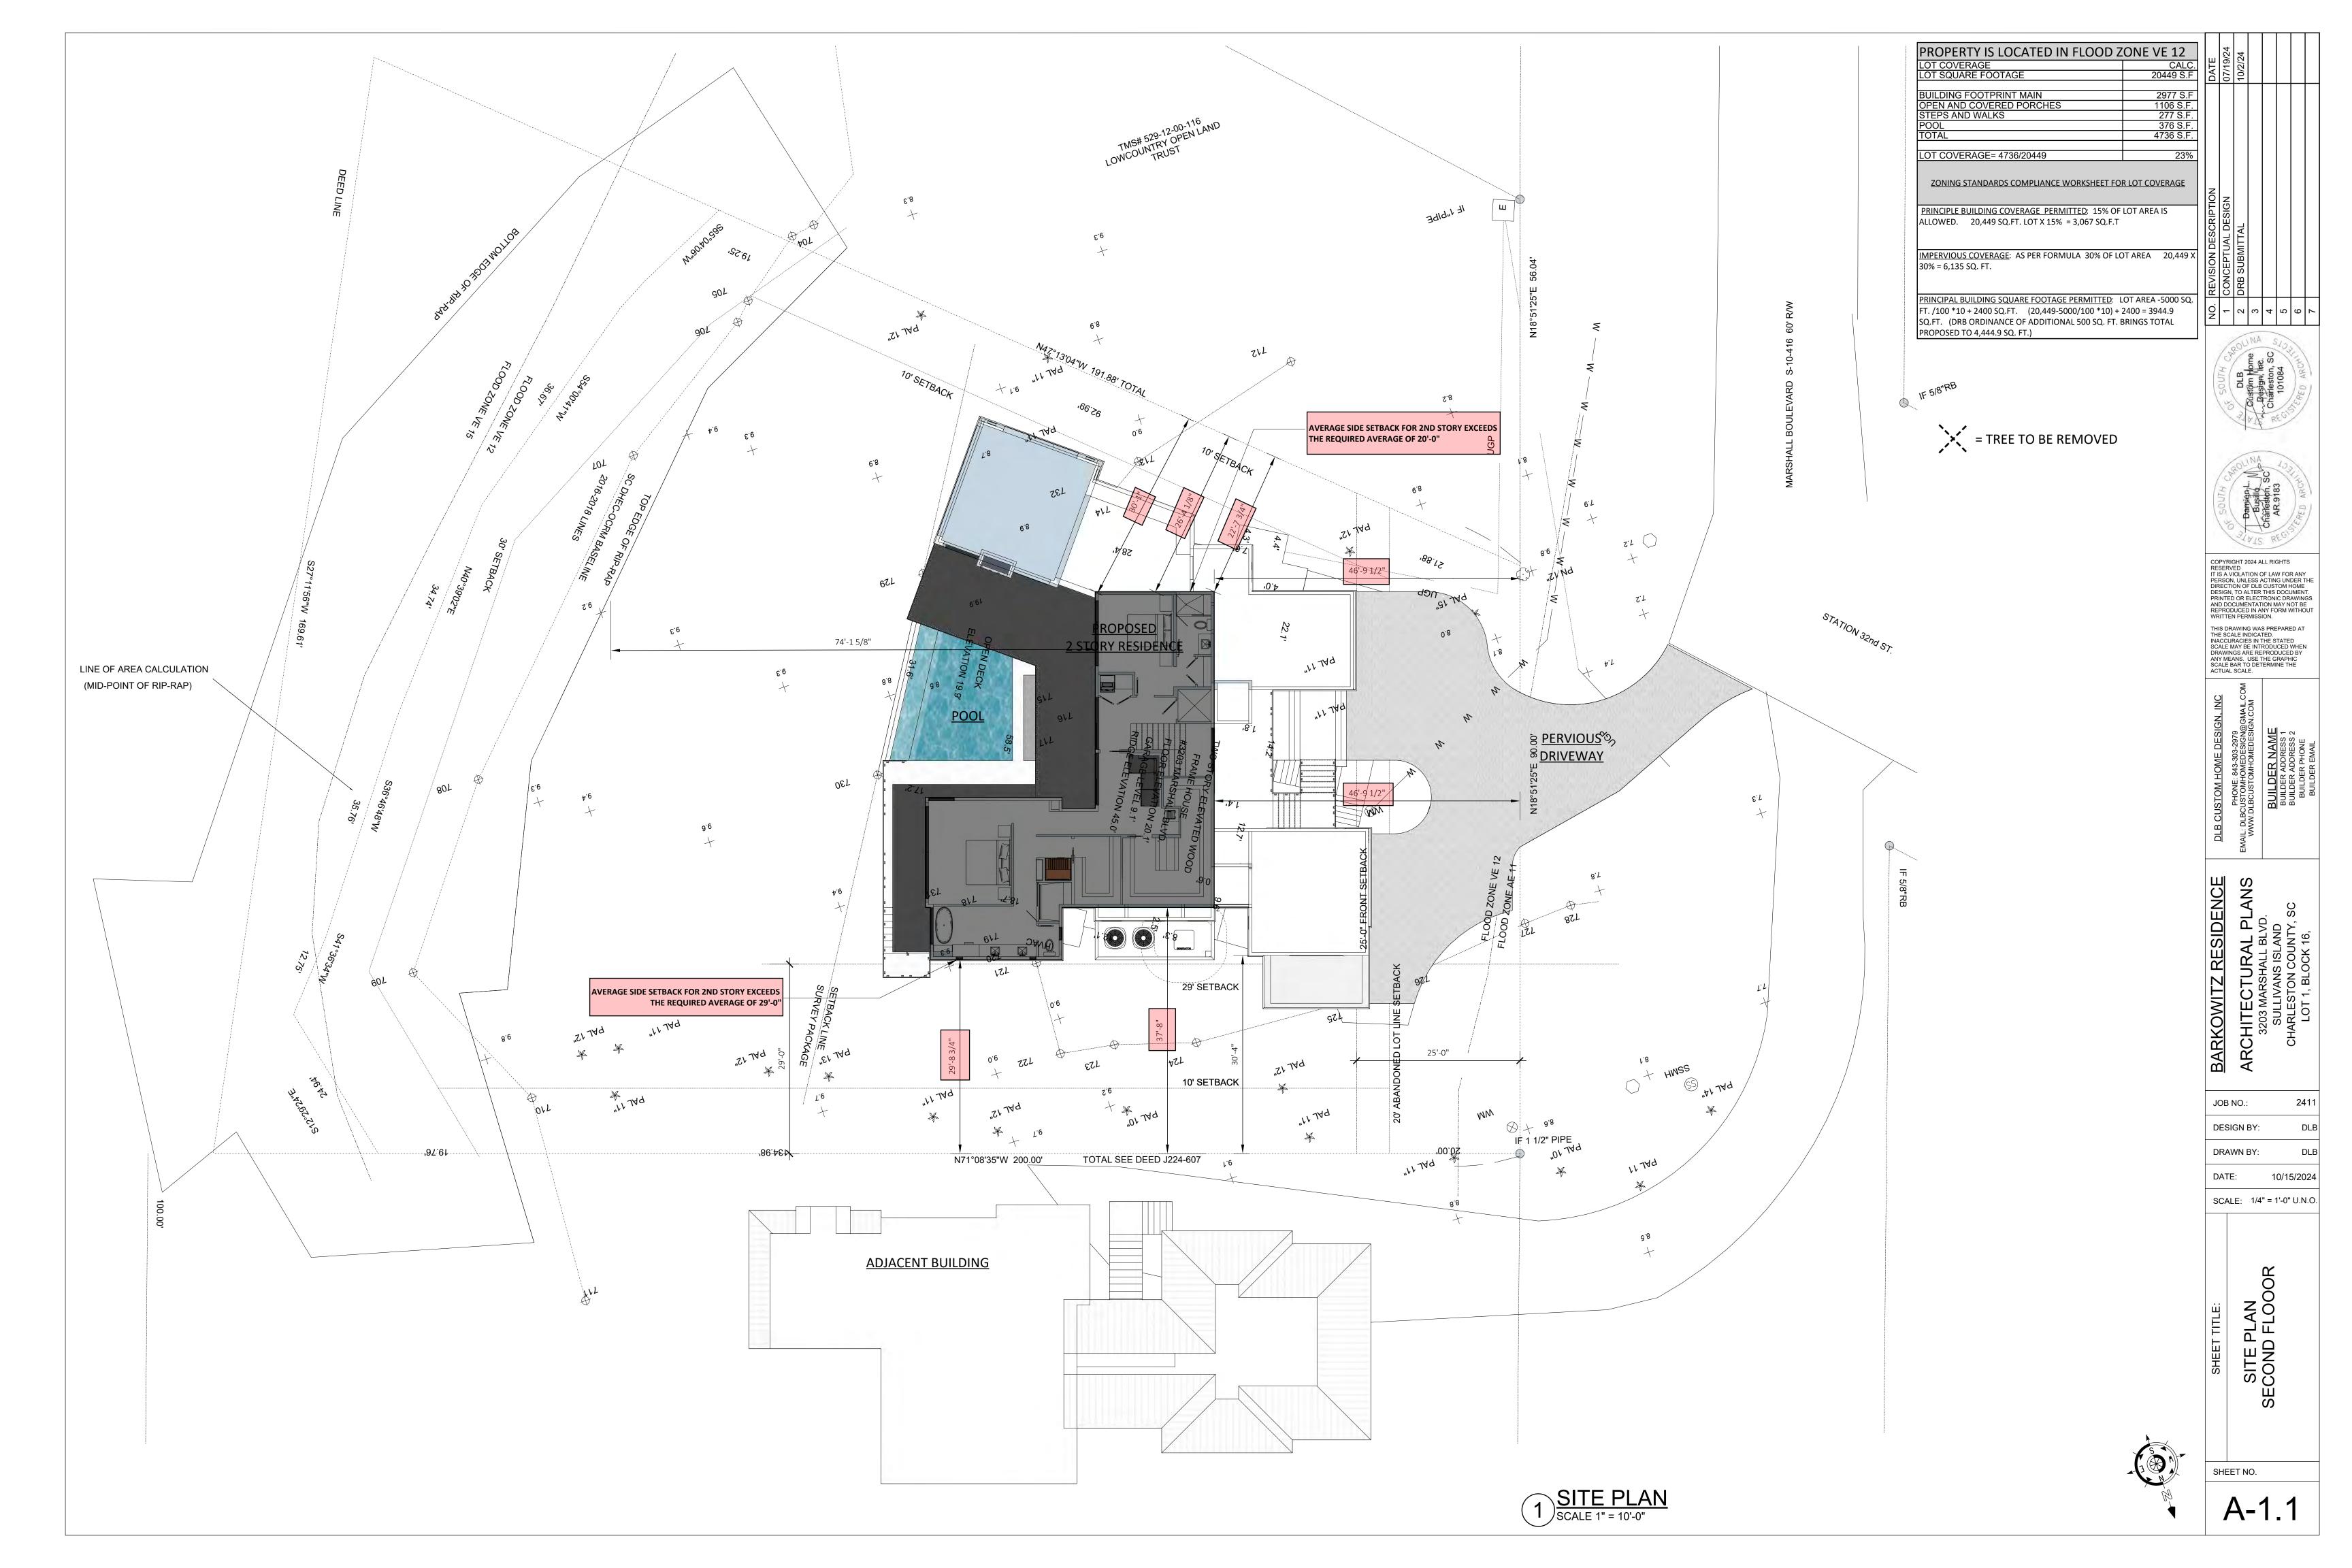

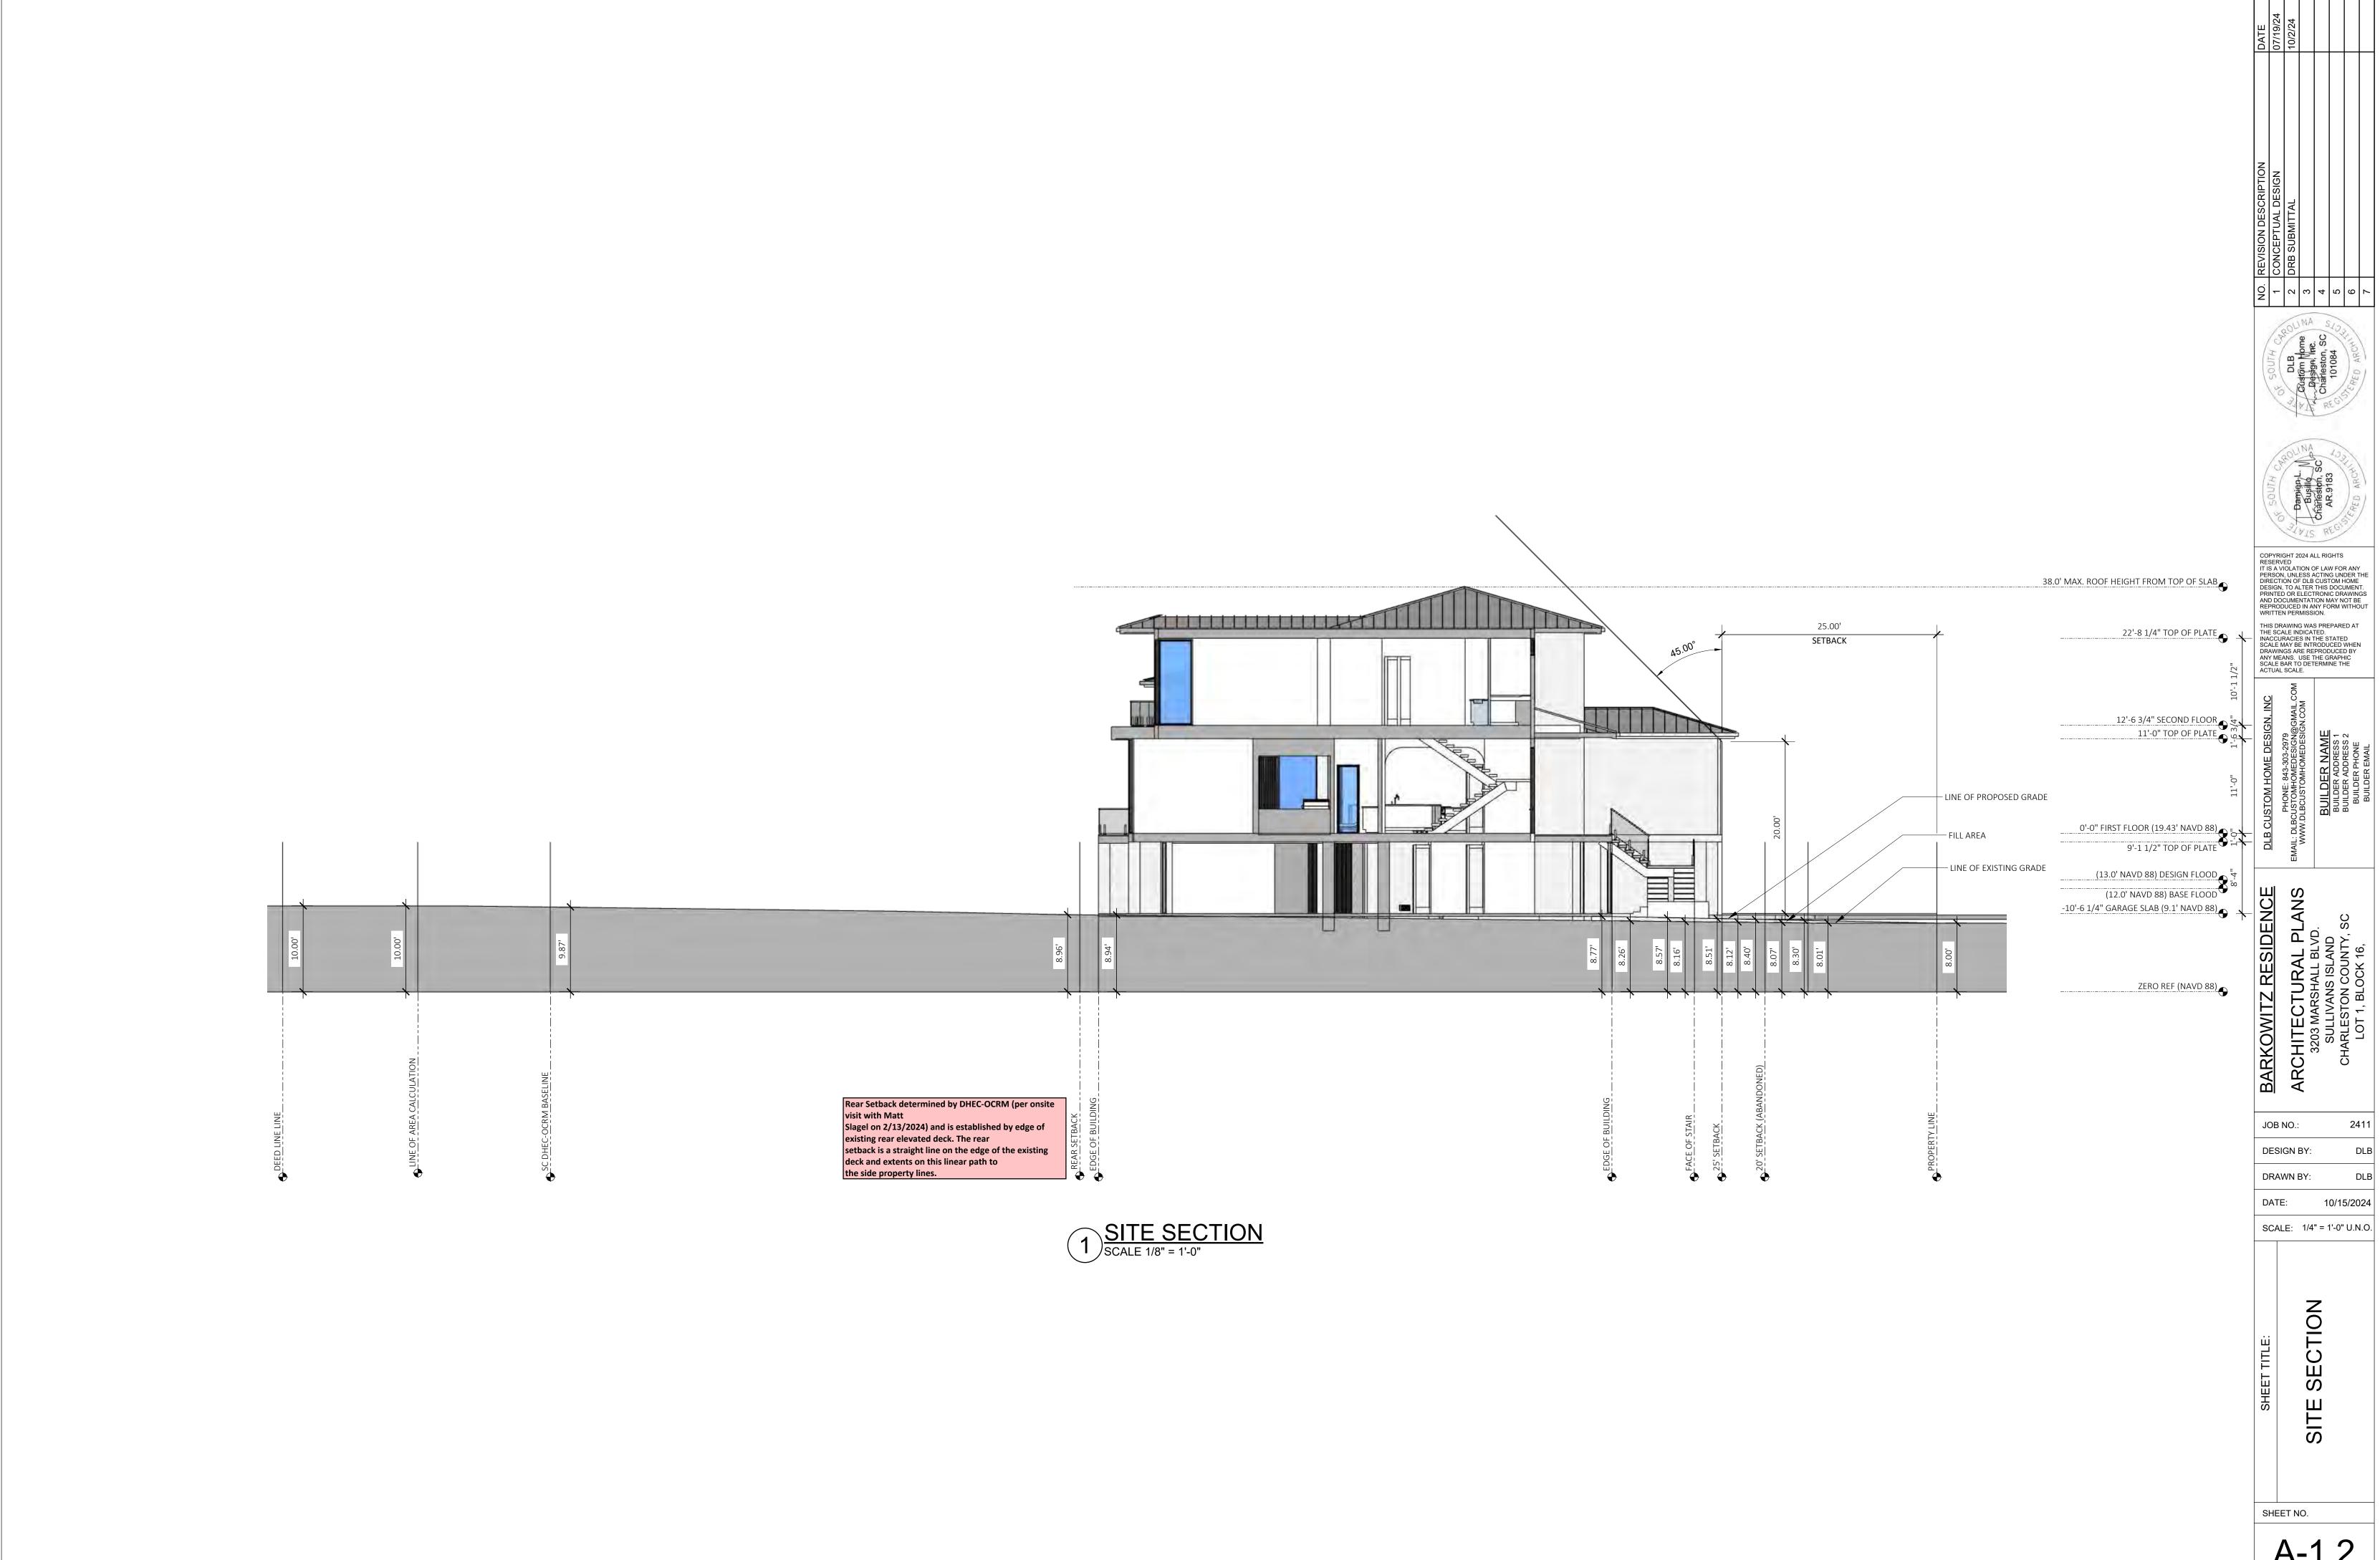

A-1.2

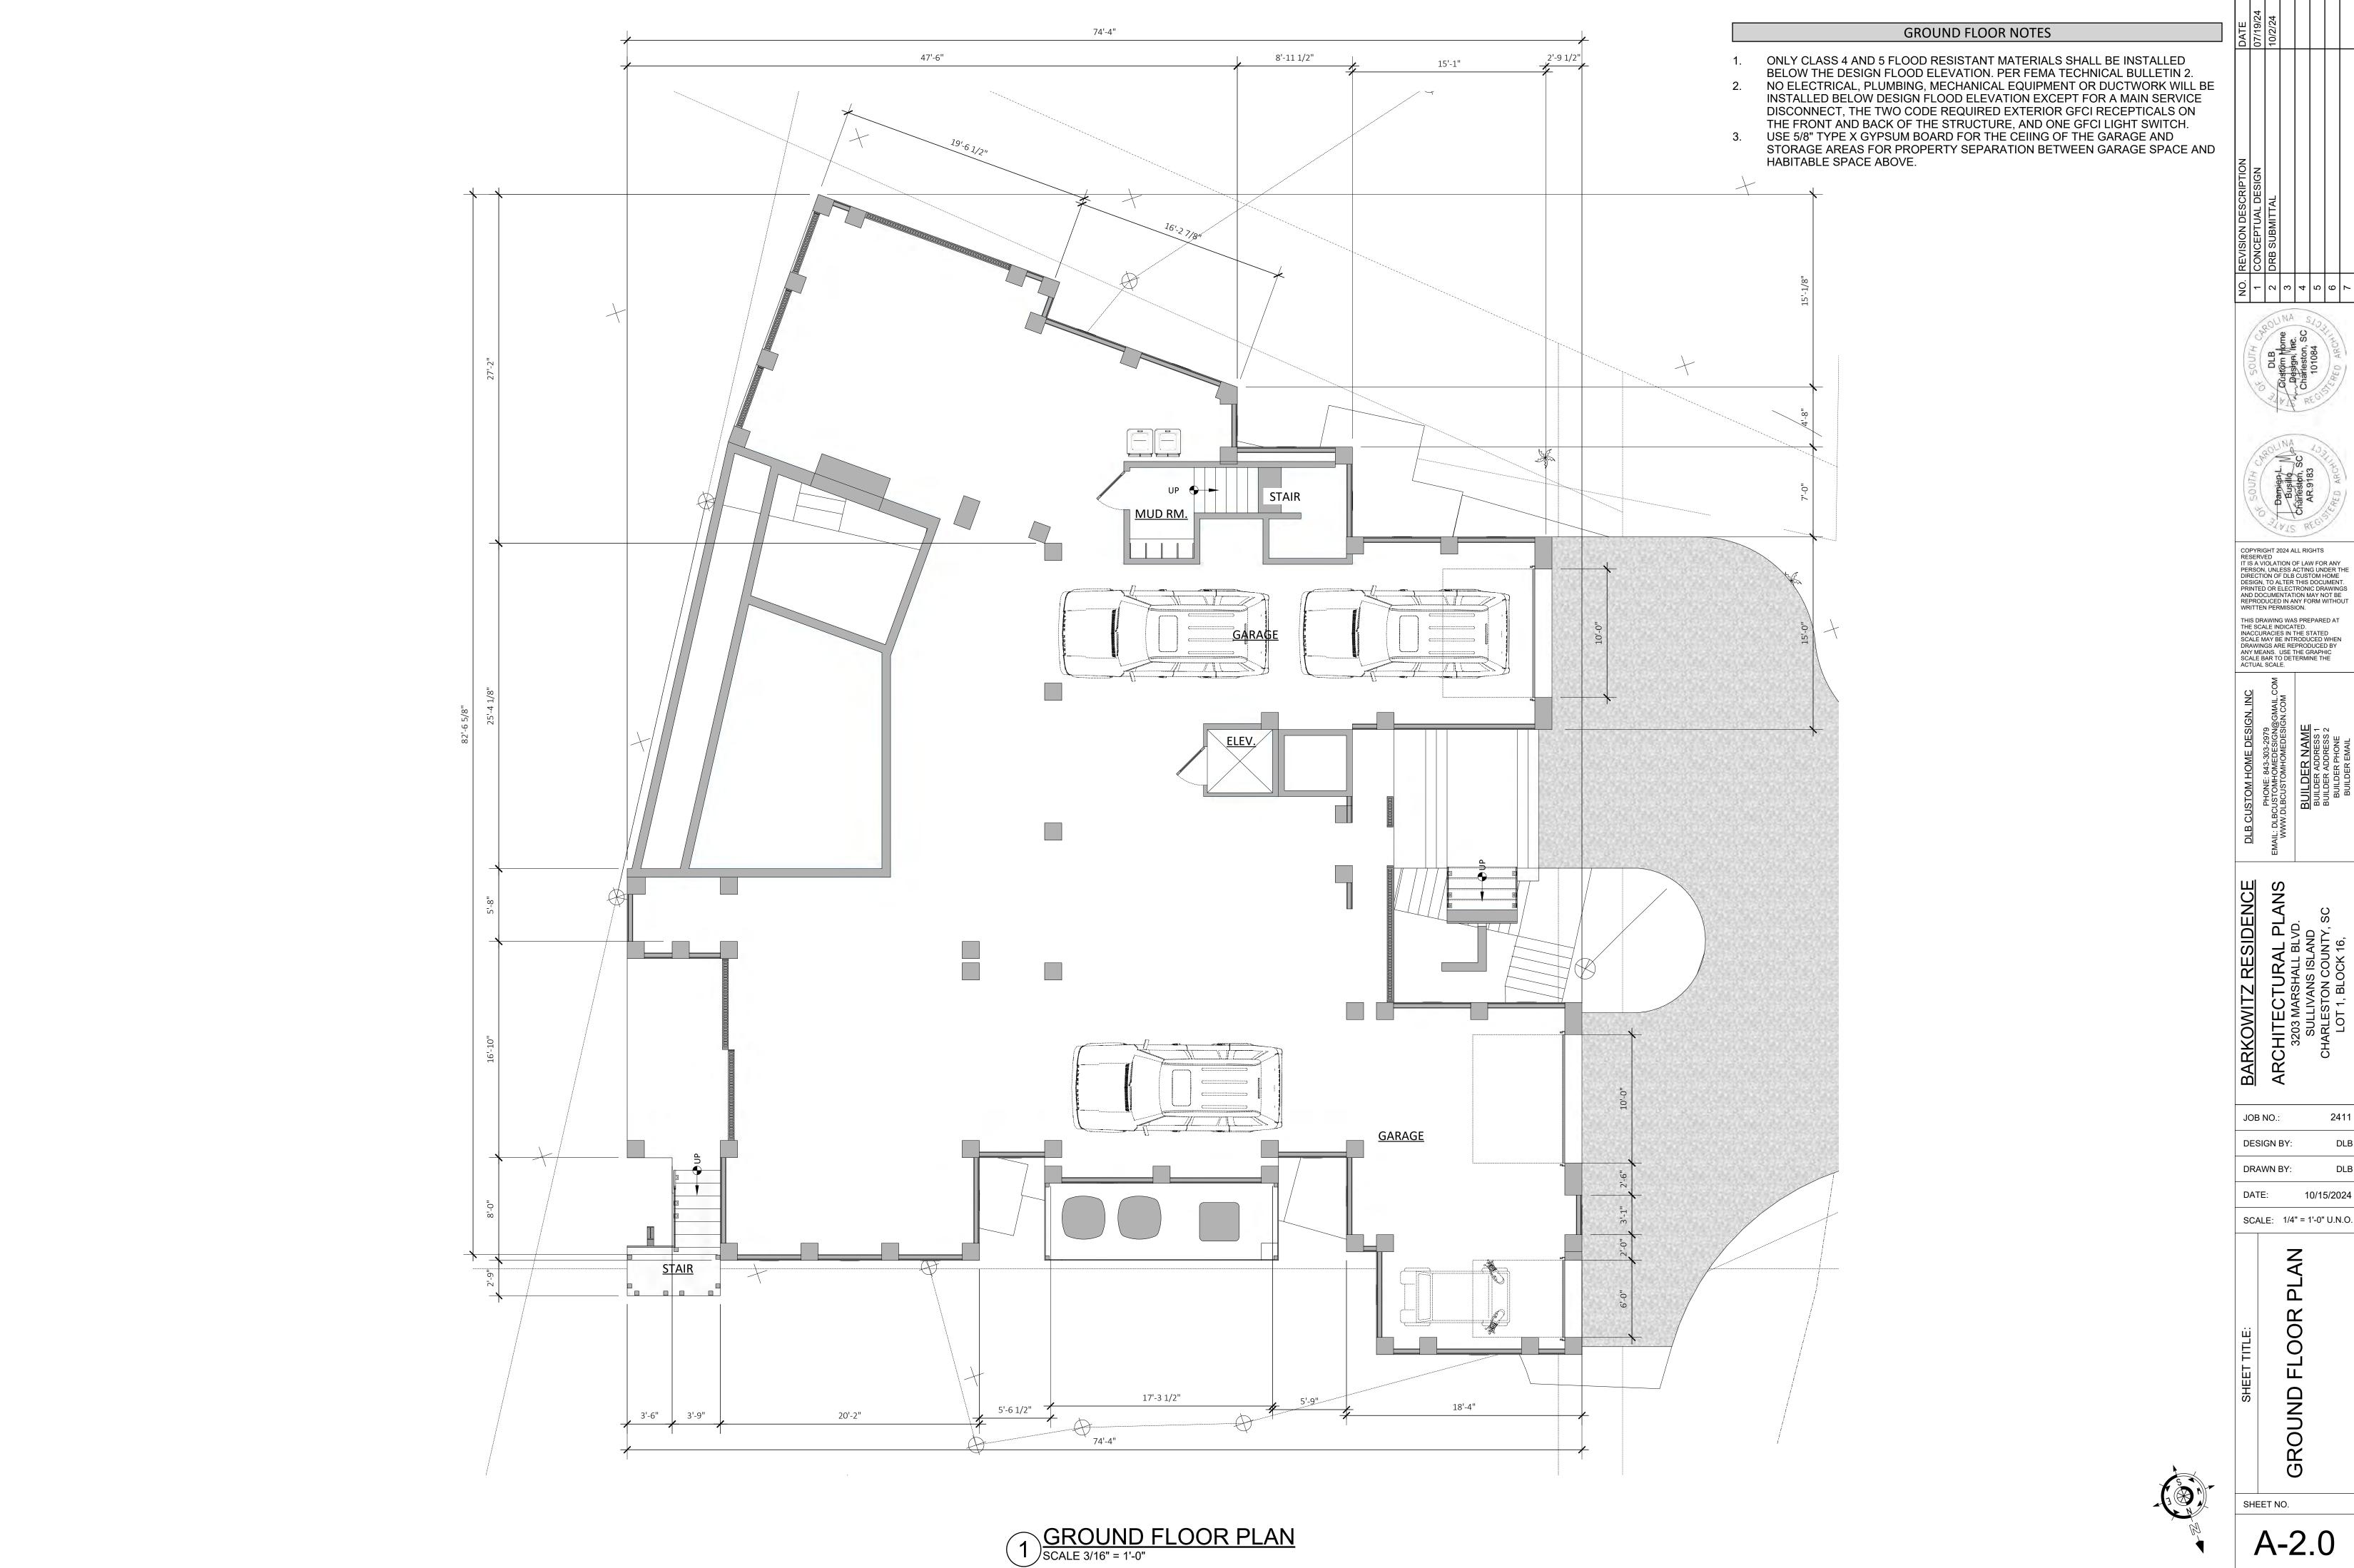

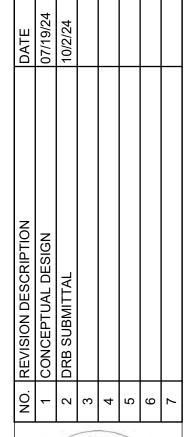





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DRAWN BY:


10/15/2024


GROUND FLOOR PL

SHEET NO.

A-2.0



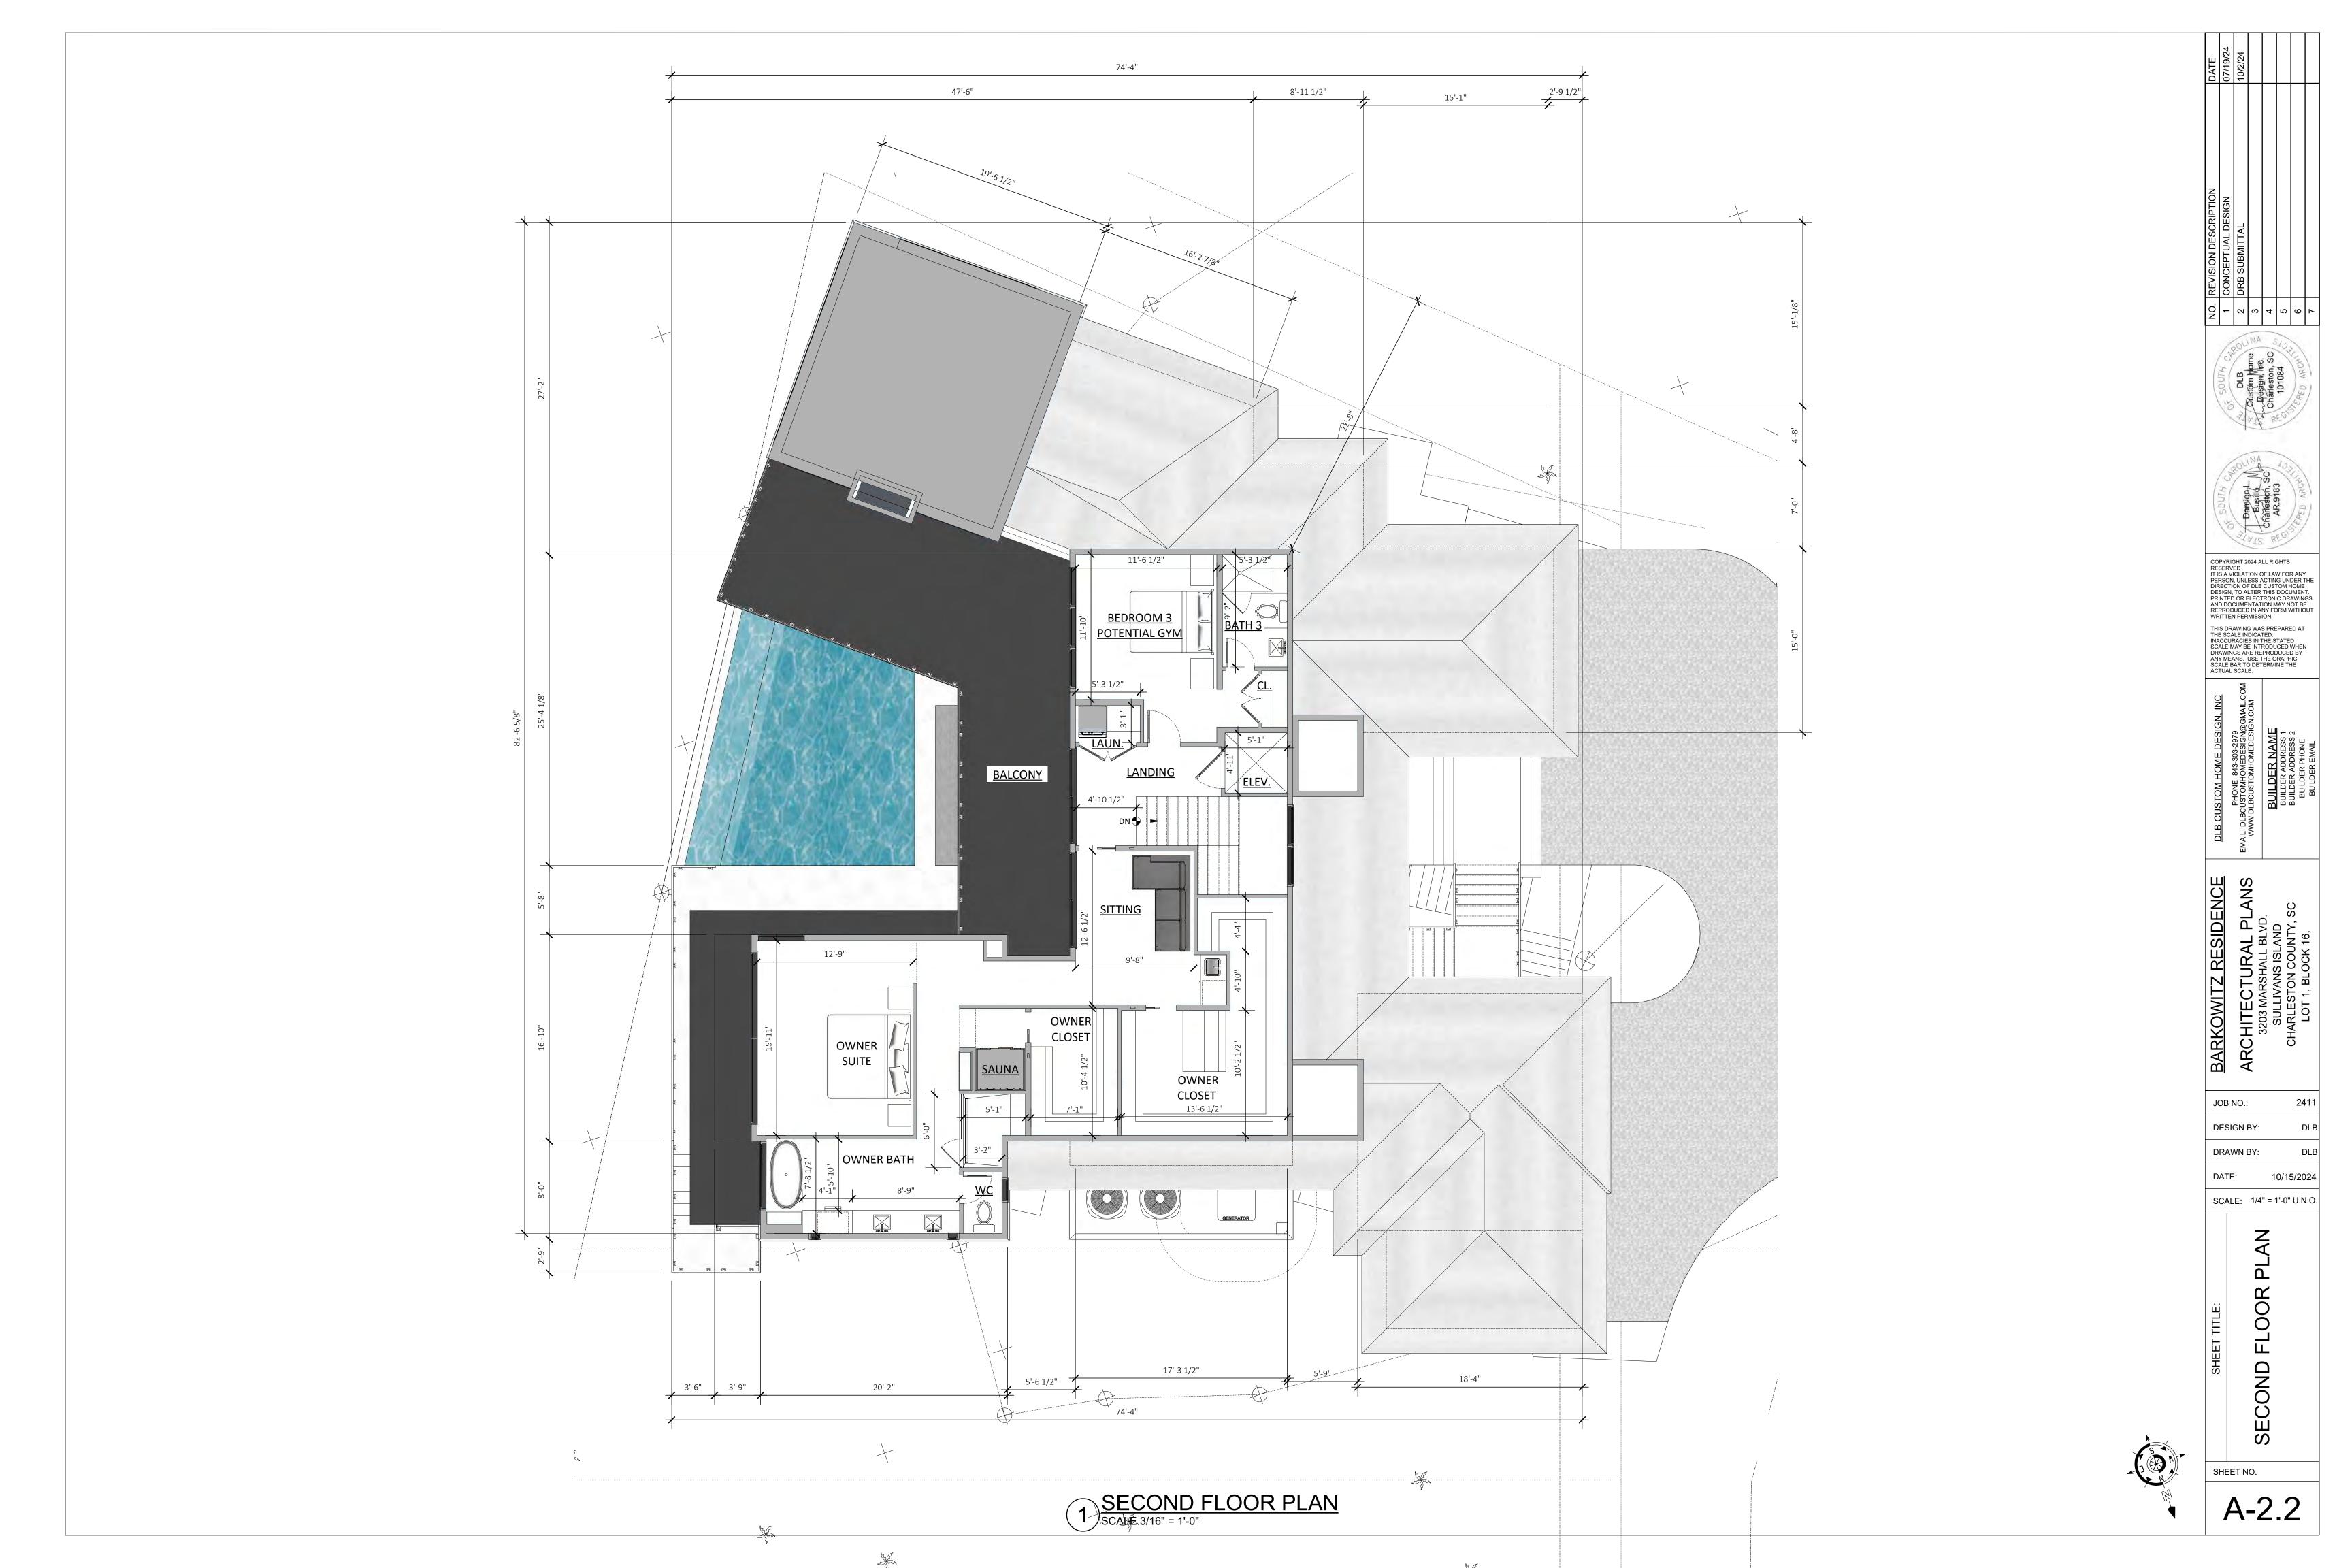

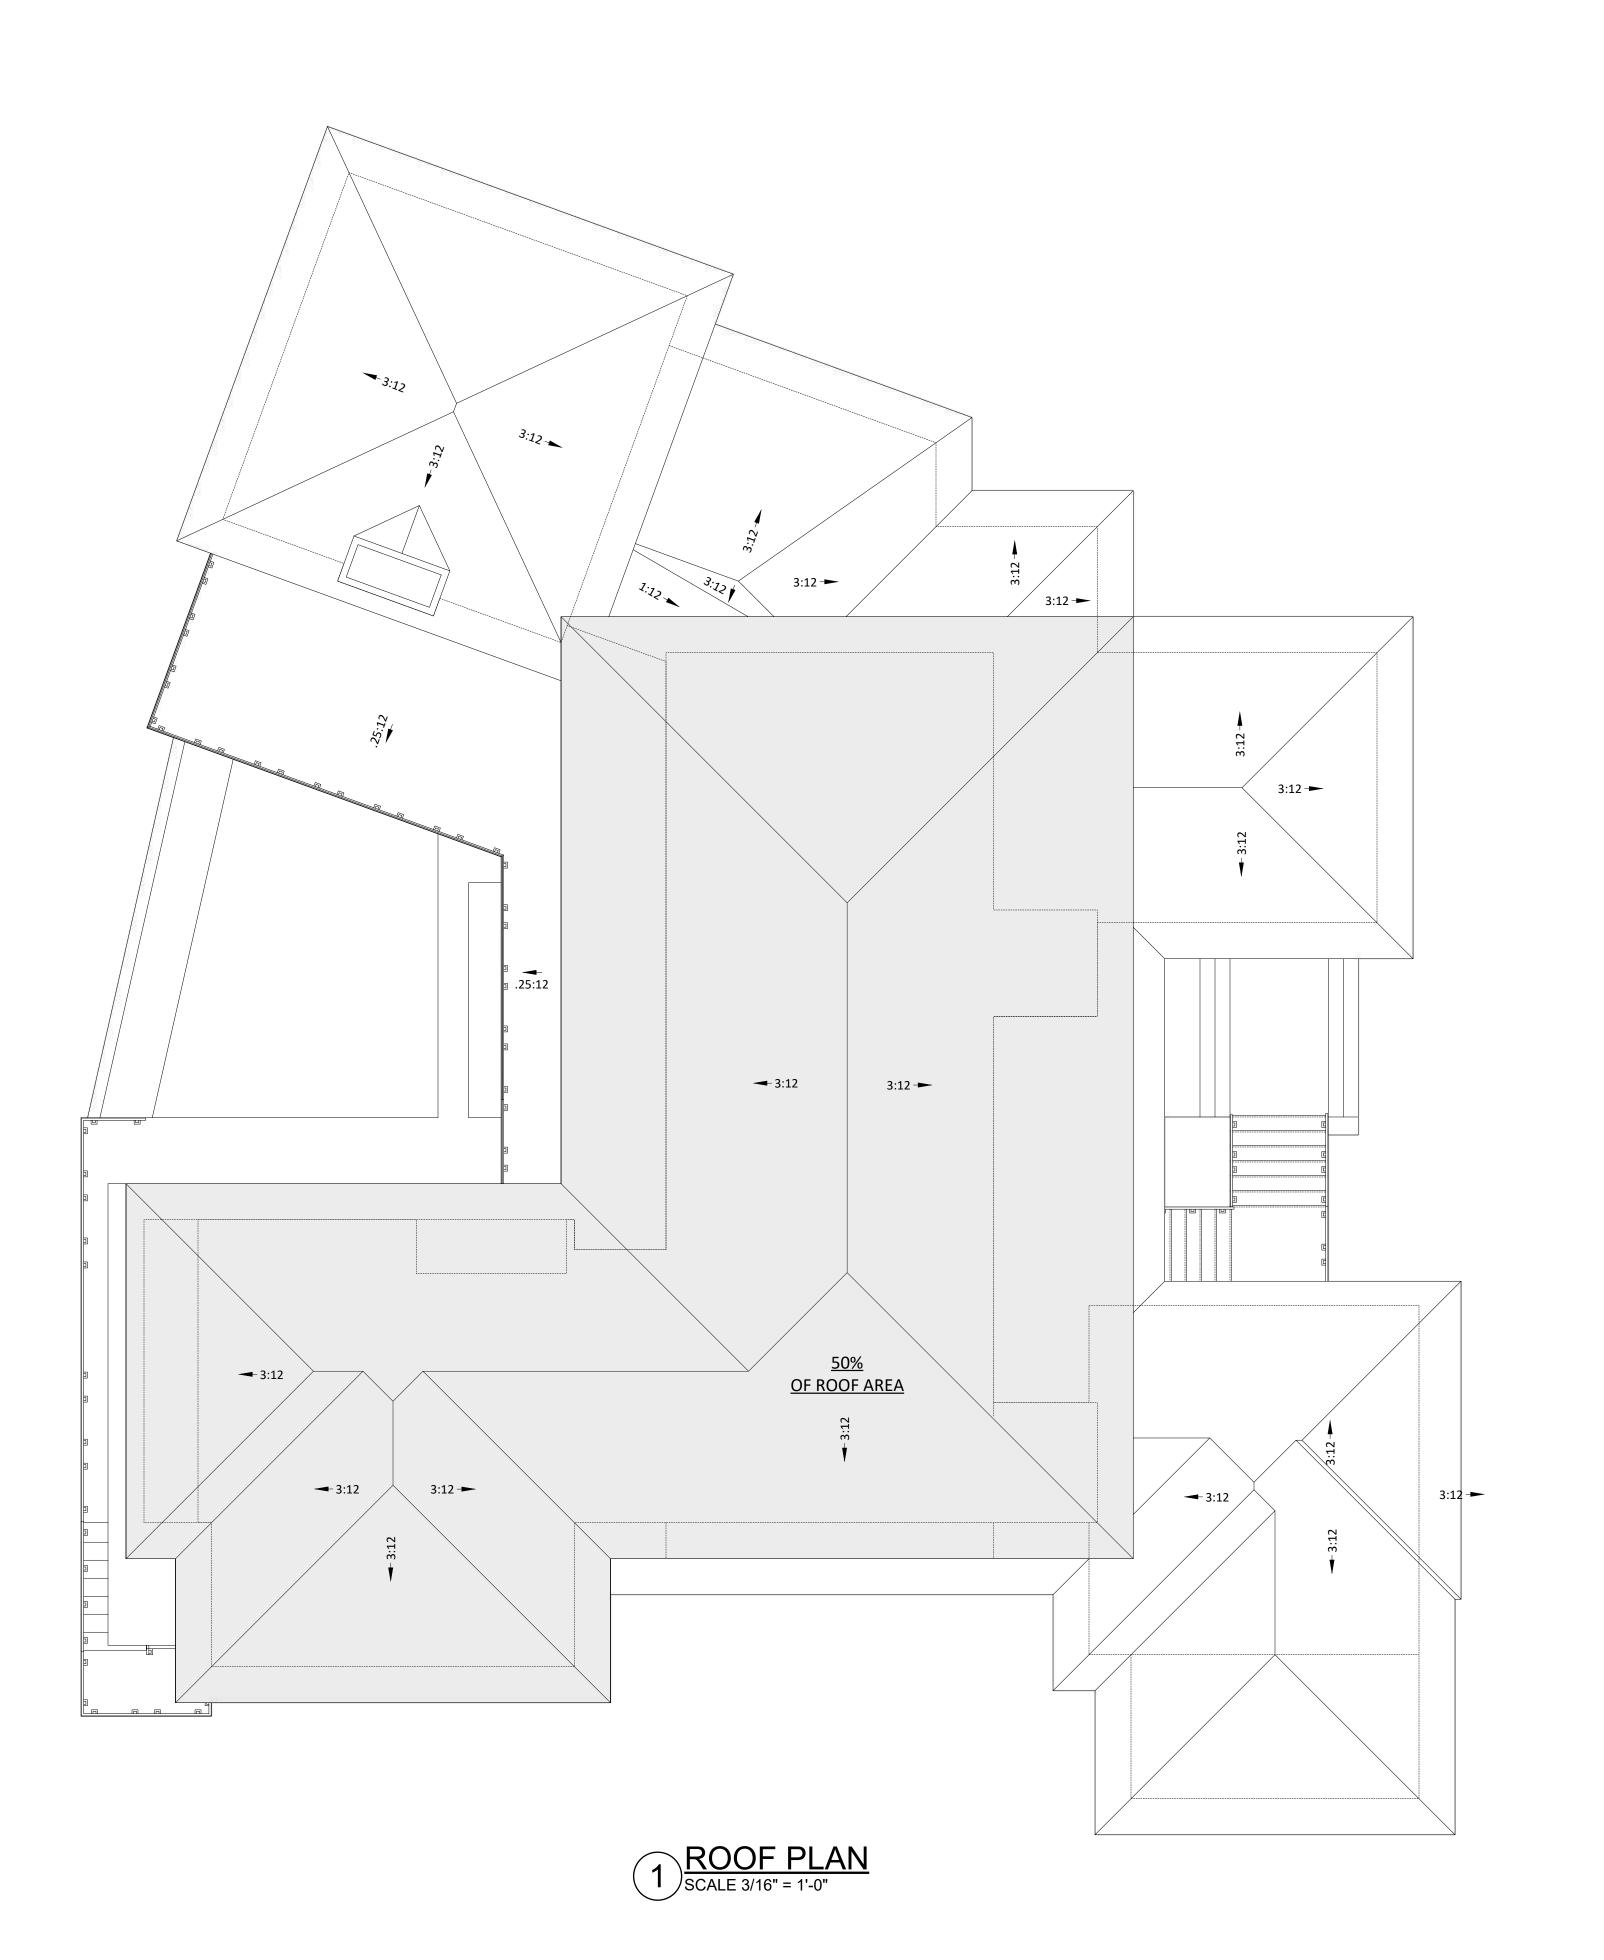


ROOF PLAN NOTES

1. HEIGHTS GIVEN ON THIS PLAN ARE FROM 0'-0" TOP OF FIRST FLOOR SUB-FLOOR.

NEGATIVE NUMBERS ARE BELOW THE FIRST FLOOR DATUM. UNLESS NOTED OTHERWISE.

2. PLATE HEIGHTS ON ROOF PLANS ARE CALCULATED USING 2x10 RAFTERS WITH 2 1/4" BIRDS MOUTH OR INSIDE FACE OF STUD WHICH EVER IS LESS. FOR 2x8 RAFTERS PLATE HEIGHTS ARE CALCULATED USING 1 3/4" BIRDS MOUTH OR INSIDE OF STUD WHICH EVER IS LESS.

ROOF AREA CALCULATION	
MAIN ROOF AREA	2424 S.
OTHER ROOF AREA	2424 S.
TOTAL ROOF AREA	4848 S.
MAIN ROOF AS PERCENTAGE	
2424/4887 =	50

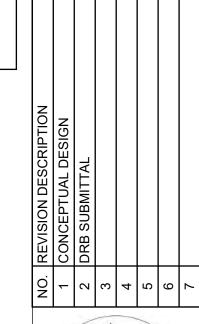





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--	--

ARCHITECTURAL PLANS
3203 MARSHALL BLVD.
SULLIVANS ISLAND
CHARLESTON COUNTY, SC

JOB NO.: 2411


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DATE: 10/15/2024


SCALE: 1/4" = 1'-0" U.N.O.

SHEET TITLE:
ROOF PLAN





SHEET NO.

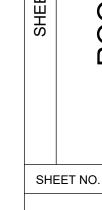4-2.3

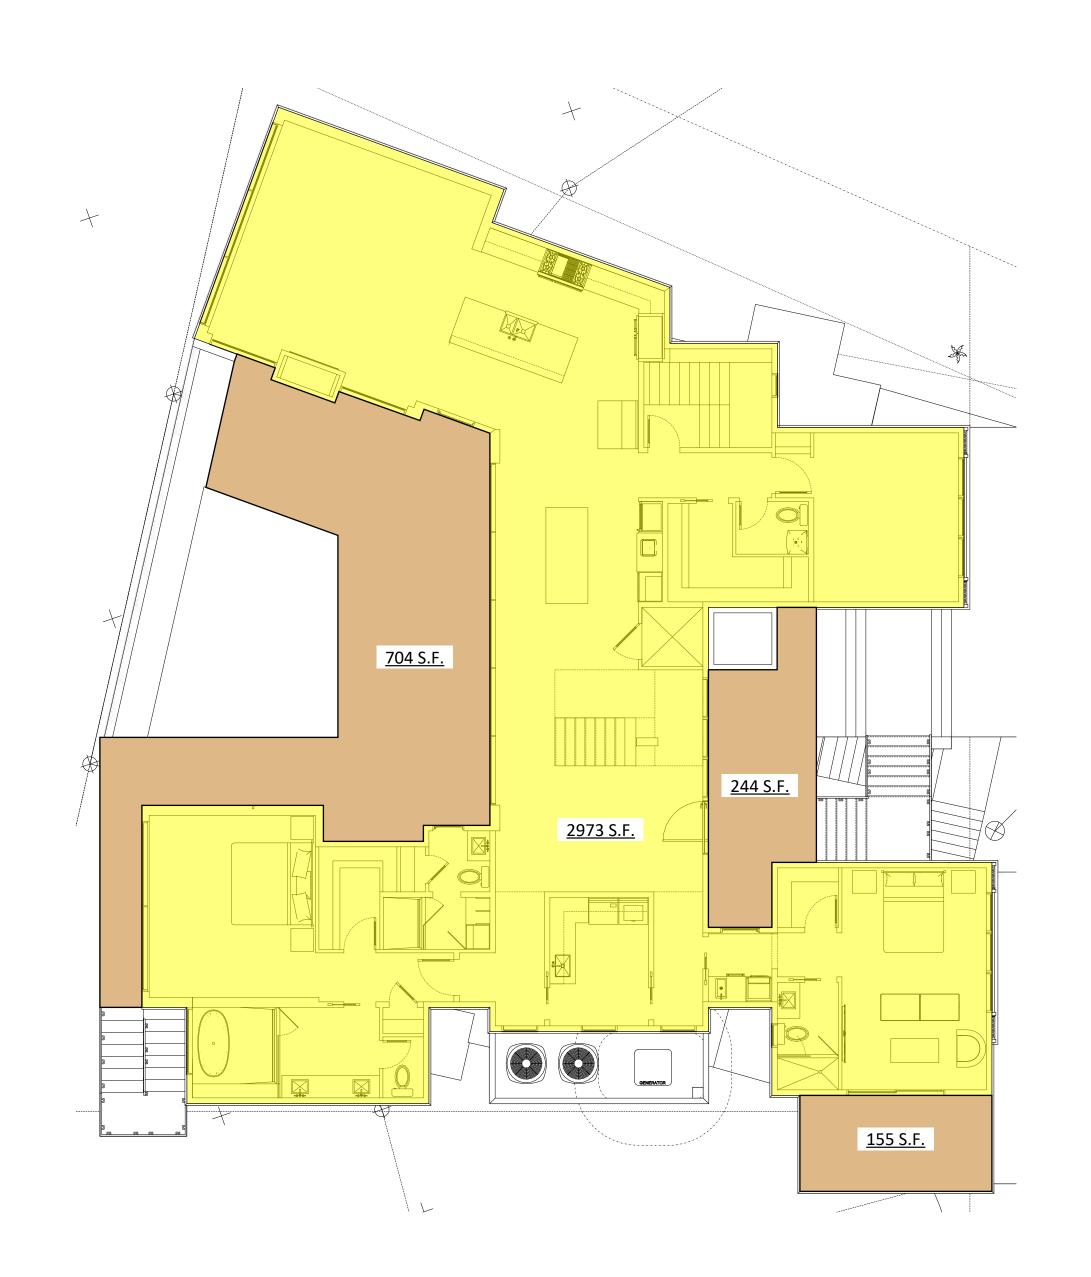


1 FIRST FLOOR PLAN SCALE 1/8" = 1'-0"

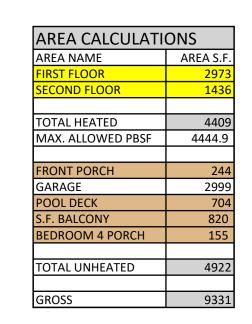

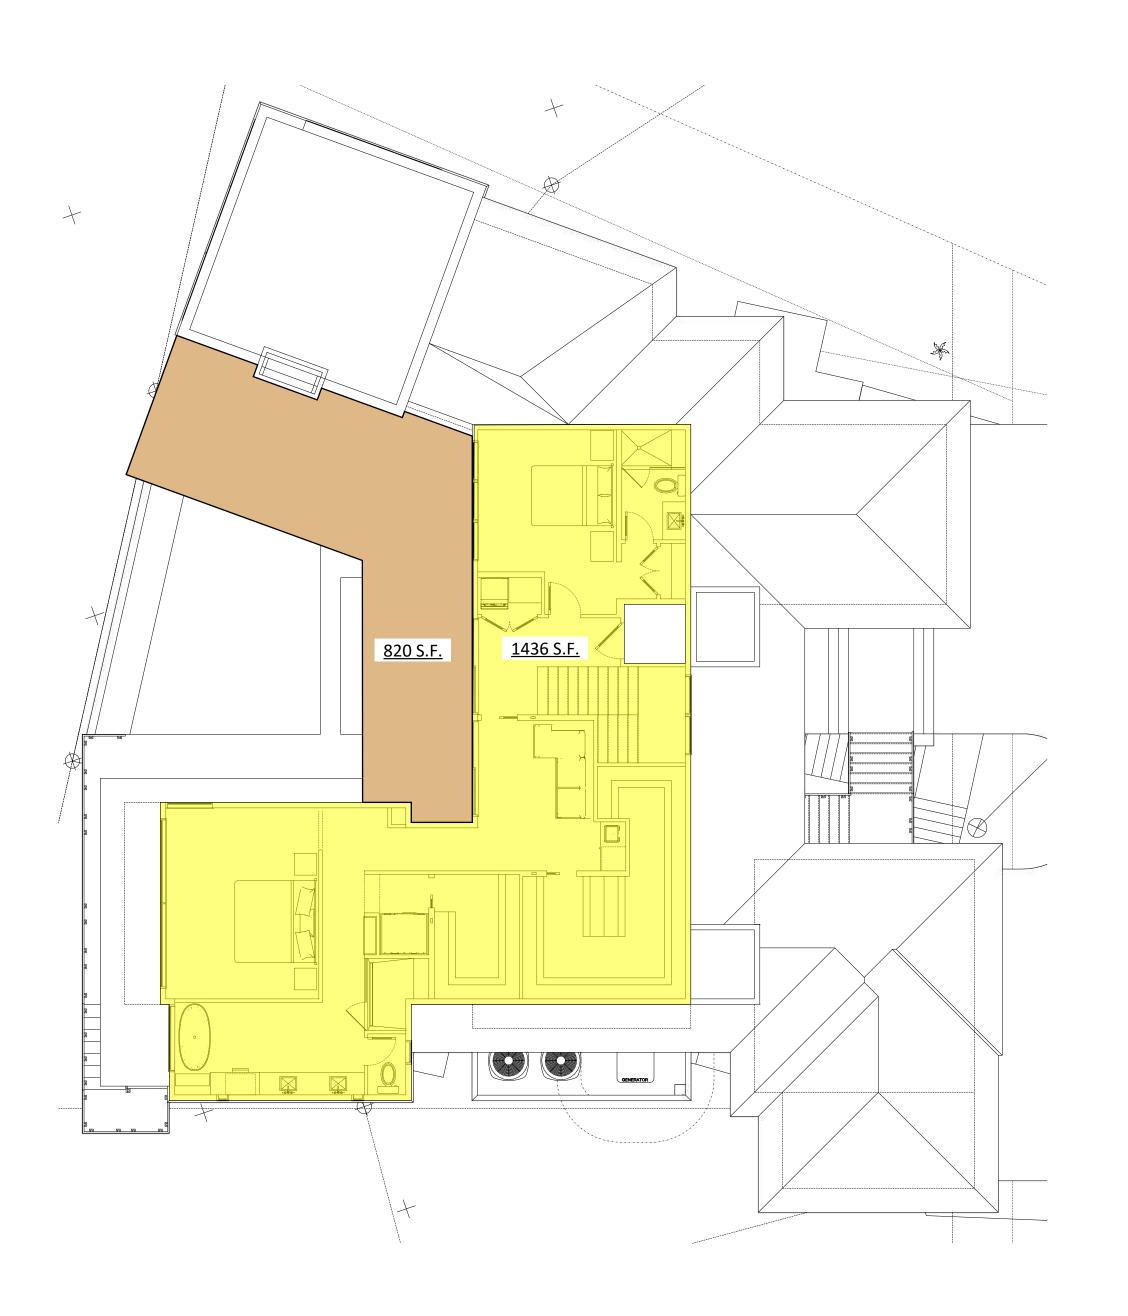

2 SECOND FLOOR PLAN SCALE 1/8" = 1'-0"

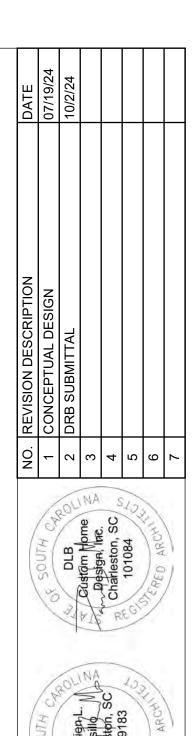



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BUILDER ADDRESS 1
BUILDER ADDRESS 2
BUILDER PHONE

BARKOWITZ RESIDENCE
ARCHITECTURAL PLANS
3203 MARSHALL BLVD.
SULLIVANS ISLAND
CHARLESTON COUNTY, SC

JOB NO.: 2411

DESIGN BY: DLB

DRAWN BY: DLB

DATE: 10/15/2024

SCALE: 1/4" = 1'-0" U.N.O.

SCALE: 1/4" = 1'-

SHEET TITLE:
GRAPHIC AREAS

SHEET NO.

A-2.4



ZERO REF (NAVD 88)



 NO. REVISION DESCRIPTION
 DATE

 1 CONCEPTUAL DESIGN
 07/19/24

 2 DRB SUBMITTAL
 10/2/24

 3
 4

 5
 6

 6
 7





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BARKOWITZ RESIDENCE
ARCHITECTURAL PLANS
3203 MARSHALL BLVD.
SULLIVANS ISLAND
CHARLESTON COUNTY, SC
LOT 1, BLOCK 16,

JOB NO.: 241

DESIGN BY: DI

DRAWN BY: DI

DATE: 10/15/2024 SCALE: 1/4" = 1'-0" U.N.O.

FRONT ELEVATION

SHEET NO.



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ARCHITECTURAL PLANS
3203 MARSHALL BLVD.
SULLIVANS ISLAND
CHARLESTON COUNTY, SC
LOT 1, BLOCK 16,

JOB NO.: DESIGN BY:

DRAWN BY: DATE: 10/15/2024 SCALE: 1/4" = 1'-0" U.N.O.

FRONT ELEVATION IN CONTEXT

SHEET NO.

A-3.1.1



ZERO REF (NAVD 88)



 NO. REVISION DESCRIPTION
 DATE

 1 CONCEPTUAL DESIGN
 07/19/24

 2 DRB SUBMITTAL
 10/2/24

 3
 4

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 6

 7
 7





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3203 MARSHALL BLVD.
SULLIVANS ISLAND
CHARLESTON COUNTY, SC
LOT 1, BLOCK 16,

JOB NO.: 2411


DESIGN BY: DLB

DRAWN BY: DLB

DATE: 10/15/2024 SCALE: 1/4" = 1'-0" U.N.O.

BACK ELEVATION

BA

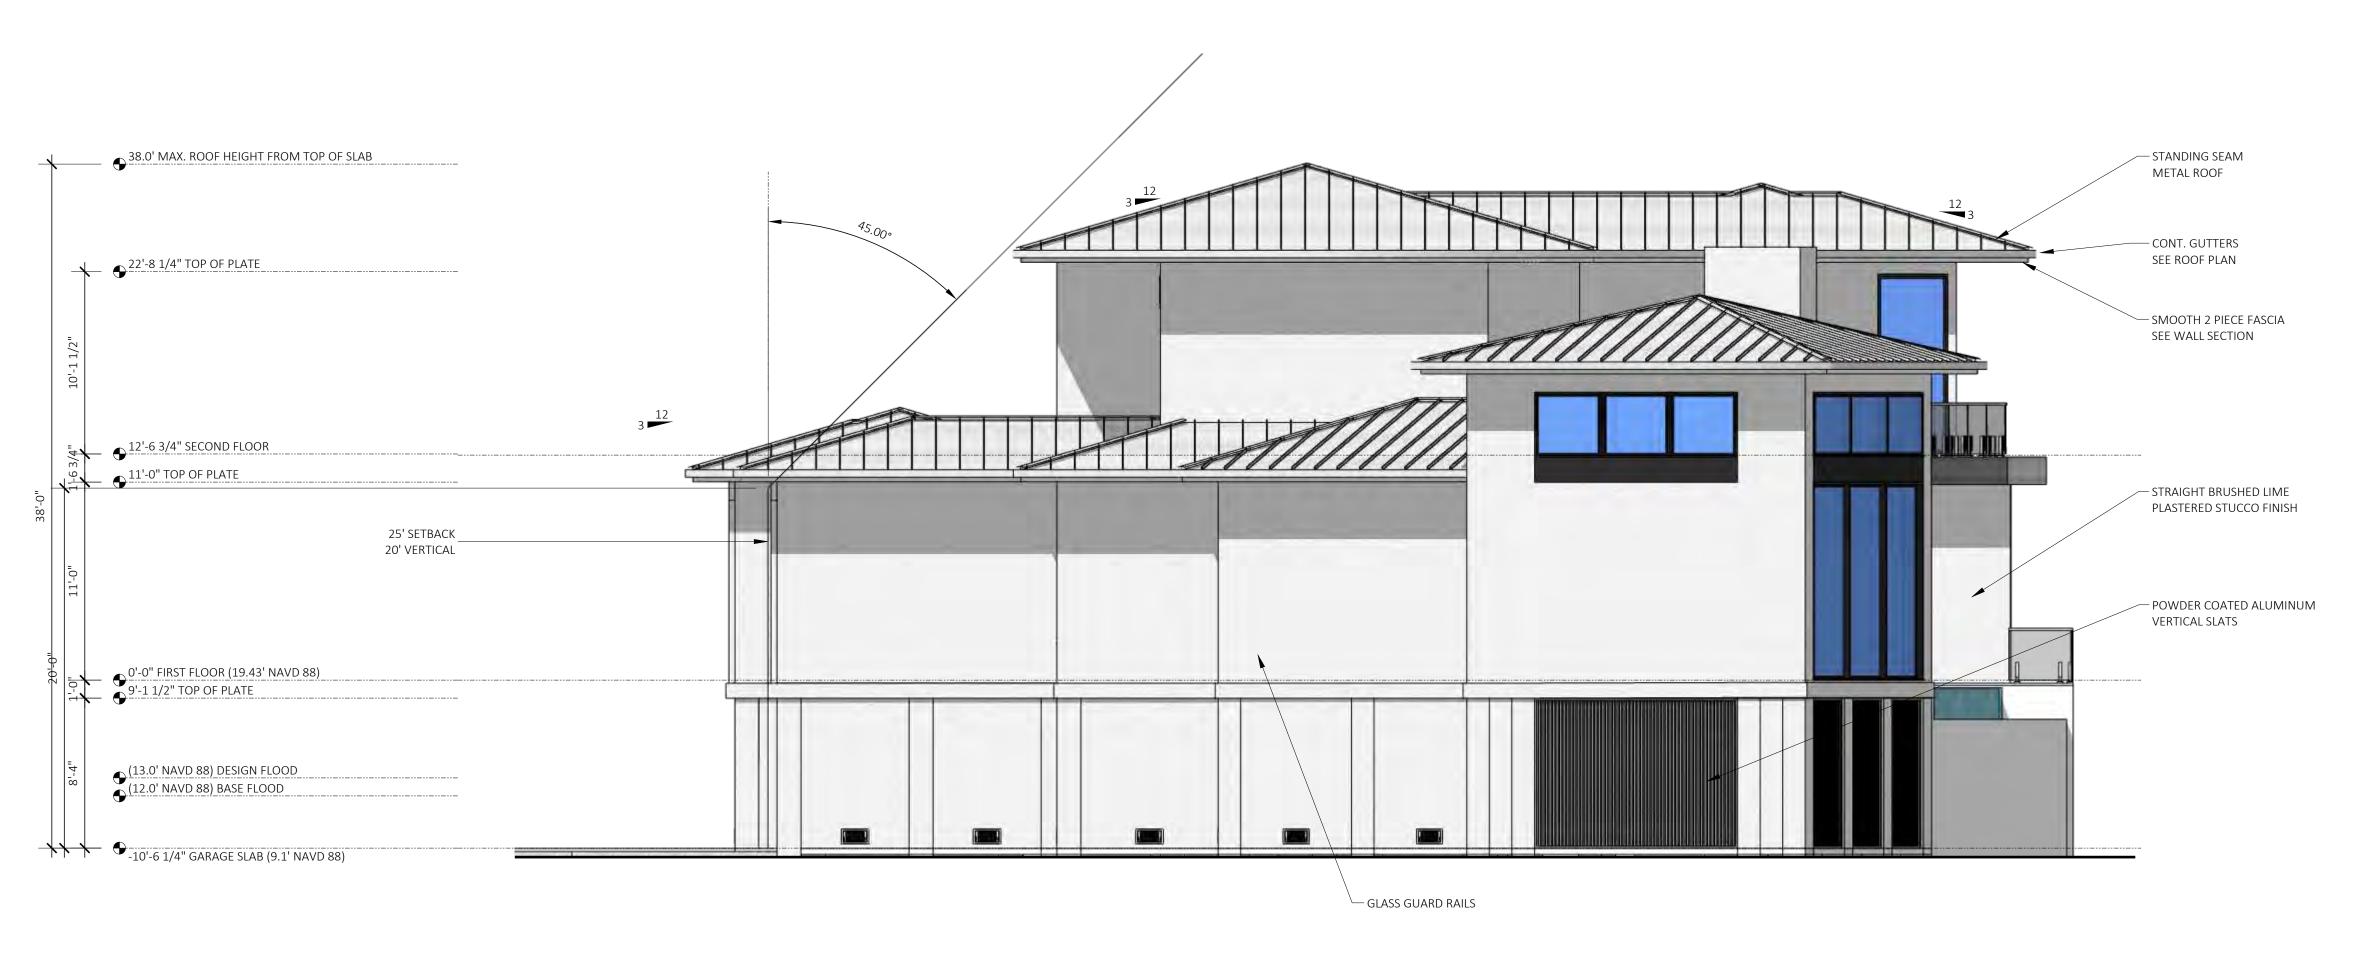

⊕ZERO REF (NAVD 88)







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3203 MARSHALL BLVD.
SULLIVANS ISLAND
CHARLESTON COUNTY, SC
LOT 1, BLOCK 16,

JOB NO.: DESIGN BY: DRAWN BY:

DATE: 10/15/2024 SCALE: 1/4" = 1'-0" U.N.O.

RIGHT ELEVATION

SHEET NO.



⊕ZERO REF (NAVD 88)

1 LEFT ELEVATION
SCALE 3/16" = 1'-0"

 NO. REVISION DESCRIPTION
 DATE

 1 CONCEPTUAL DESIGN
 07/19/24

 2 DRB SUBMITTAL
 10/2/24

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 6

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BUILDER ADDRESS 2
BUILDER PHONE

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SULLIVANS ISLAND
CHARLESTON COUNTY, SC
LOT 1, BLOCK 16,

JOB NO.: 241

DESIGN BY: DL

DRAWN BY: DL

DATE: 10/15/2024

SCALE: 1/4" = 1'-0" U.N.O.

T ELEVATION

SHEET NO.









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ARCHITECTURAL PLANS
3203 MARSHALL BLVD.
SULLIVANS ISLAND
CHARLESTON COUNTY, SC
LOT 1, BLOCK 16,

JOB NO.: DESIGN BY: DRAWN BY:

SCALE: 1/4" = 1'-0" U.N.O.

FRONT PERSPECTIVE

SHEET NO.





 NO.
 REVISION DESCRIPTION
 DATE

 1
 CONCEPTUAL DESIGN
 07/19/24

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 DRB SUBMITTAL
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CHARLESTON COUNTY, SC

JOB NO.: 2411

DESIGN BY: DLB

DRAWN BY: DLB

DATE: 10/15/2024 SCALE: 1/4" = 1'-0" U.N.O.

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 NO. REVISION DESCRIPTION
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 1 CONCEPTUAL DESIGN
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CHARLESTON COUNTY, SC

JOB NO.: 2411

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DATE: 10/15/2024

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BACK PERSPECTIVE

SHEET NO.





	NO.	NO. REVISION DESCRIPTION	DATE	
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BUILDER NAME

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3203 MARSHALL BLVD.
SULLIVANS ISLAND
CHARLESTON COUNTY, SC

JOB NO.: 2411

DESIGN BY: DLB


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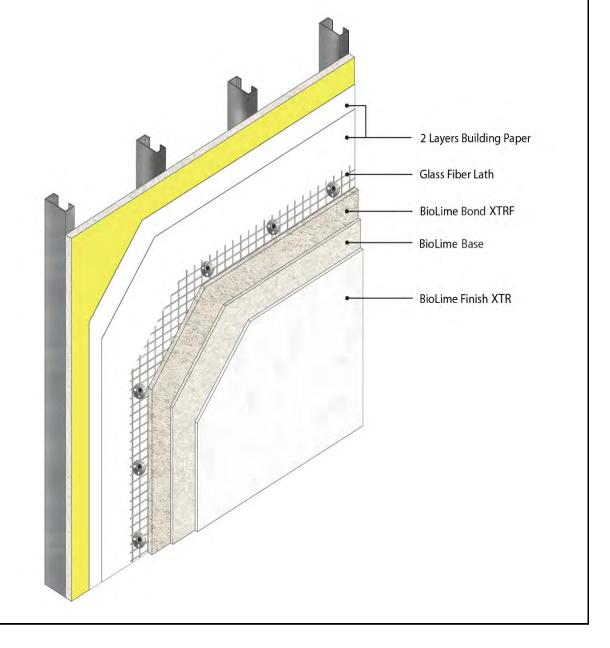
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AERIAL VIEWS

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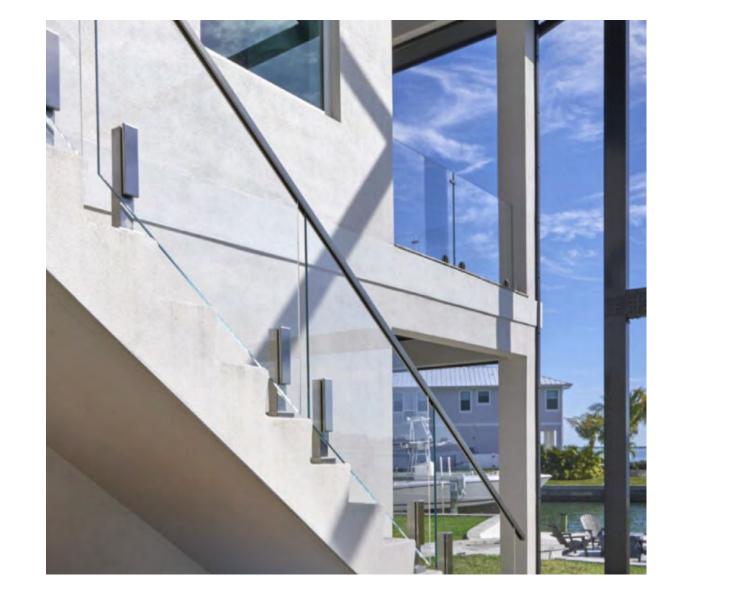
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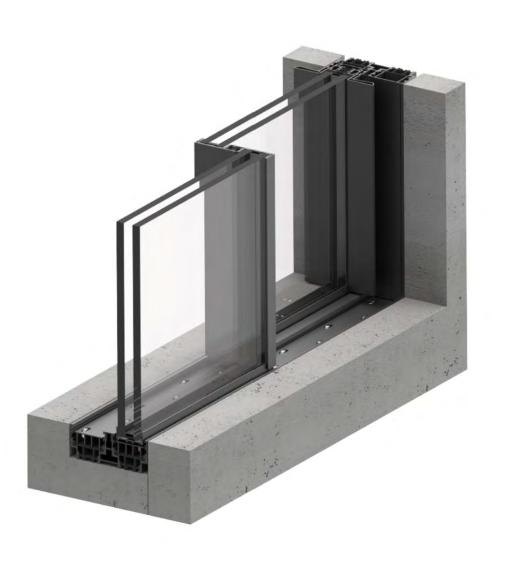
BIOLIME EXTERIOR LIME PLASTER FINISH, EXTRA FINE




24 GAUGE MECHANICALLY SEAMED METAL ROOF

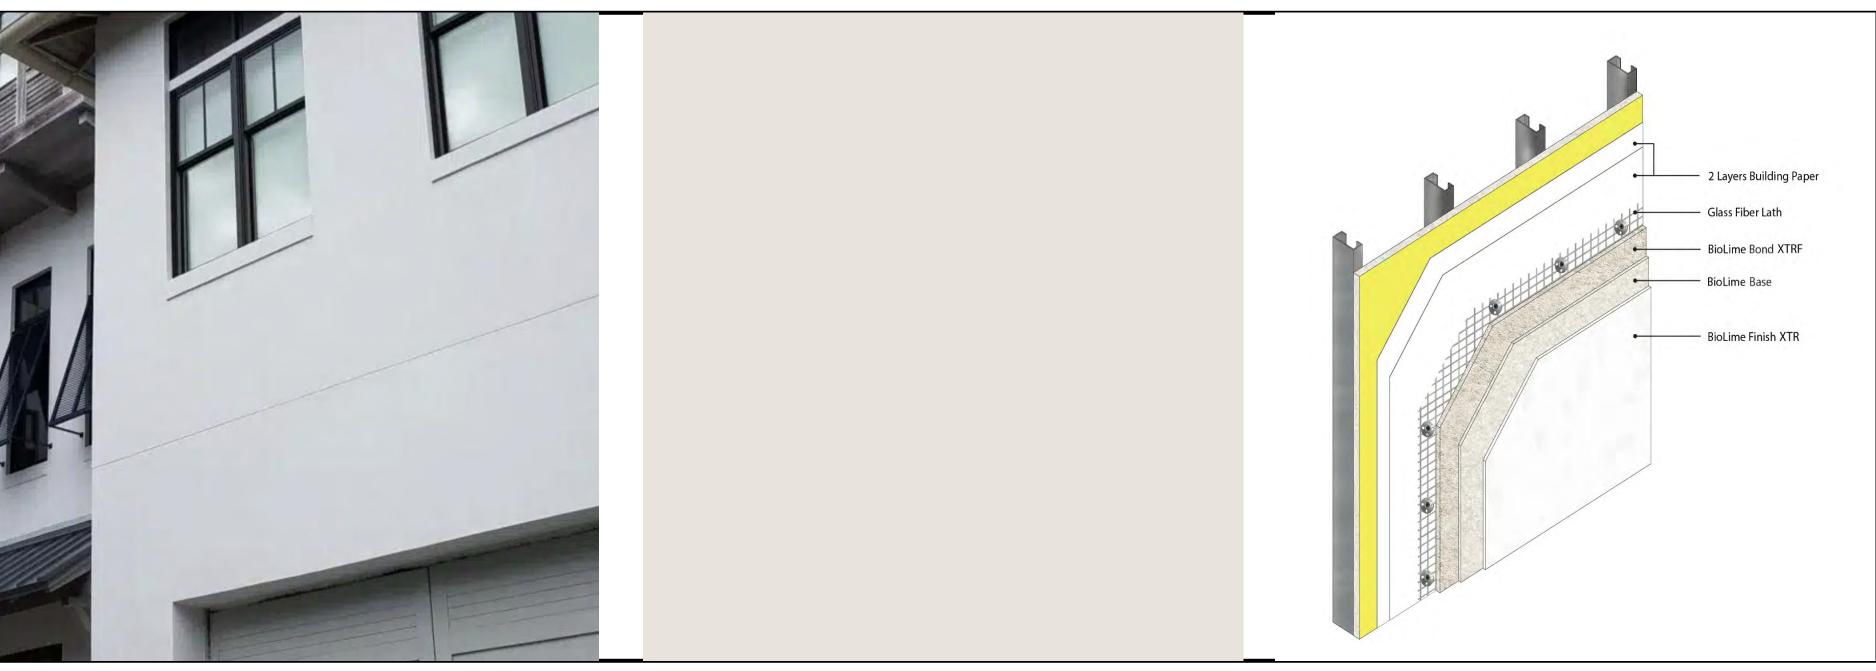

VIEWRAIL GLASS RAILING SYSTEM WITH ASCEND TALON SPIGOTS




PANORAMAH AH38 EXTERIOR WINDOWS AND DOORS

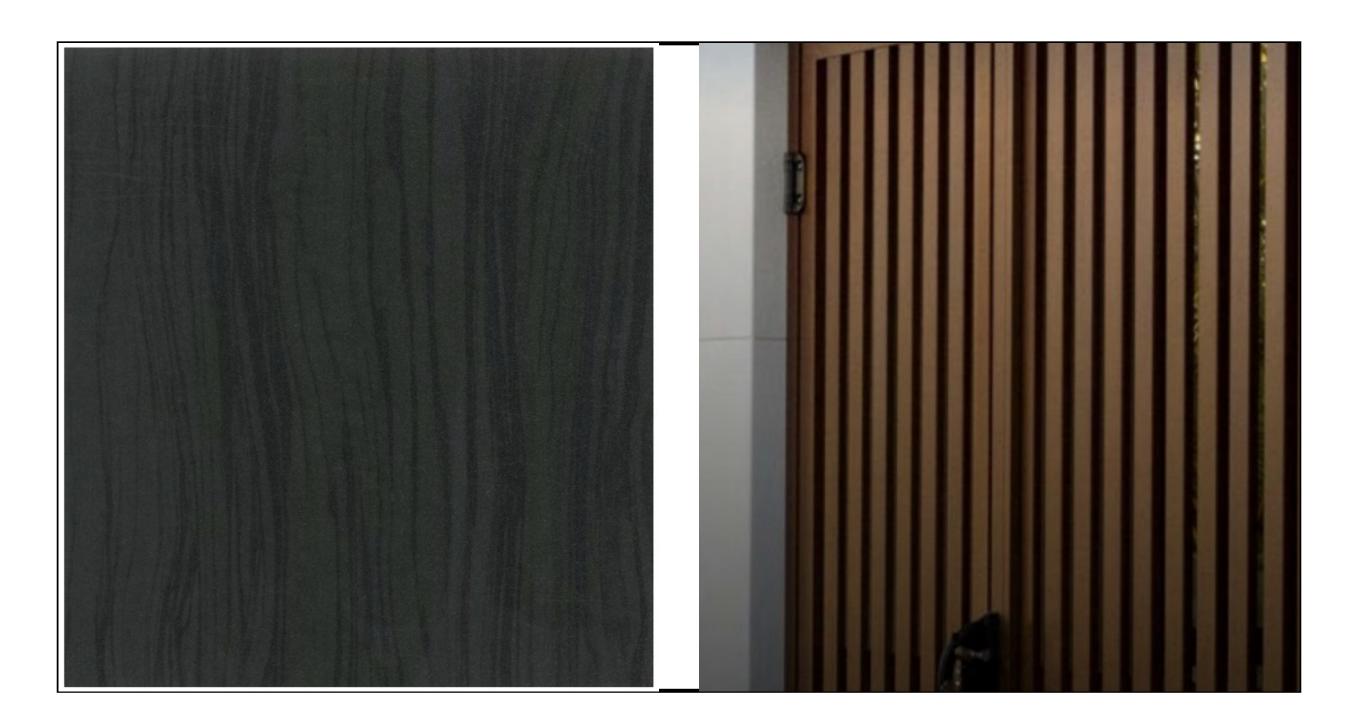


KNOTWOOD ALUMINUM SLATTED SCREEN SYSTEM IN CHARCOAL ASH WOOD GRAIN



ACCOYA SHIPLAP SIDING

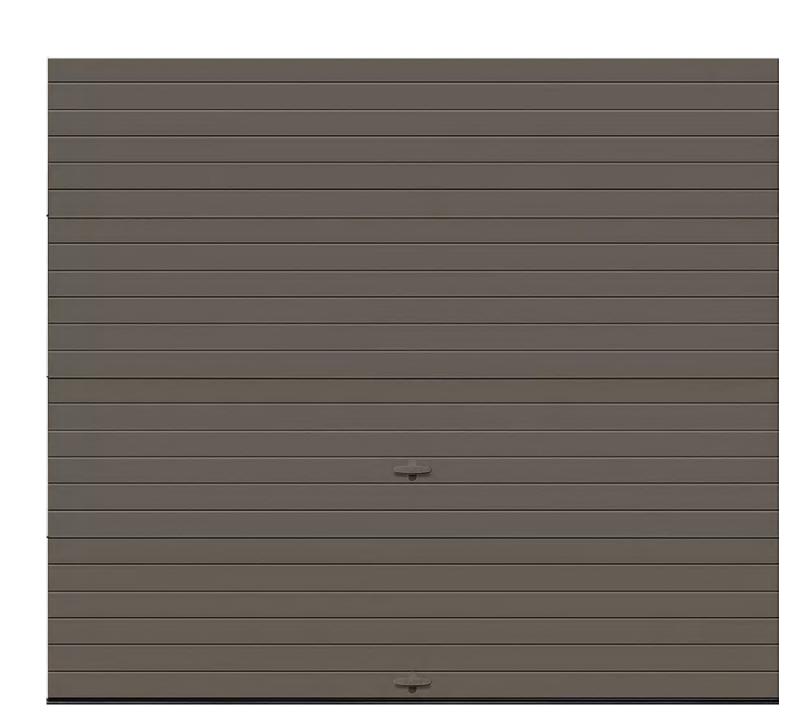

CLOPAY GARAGE DOOR

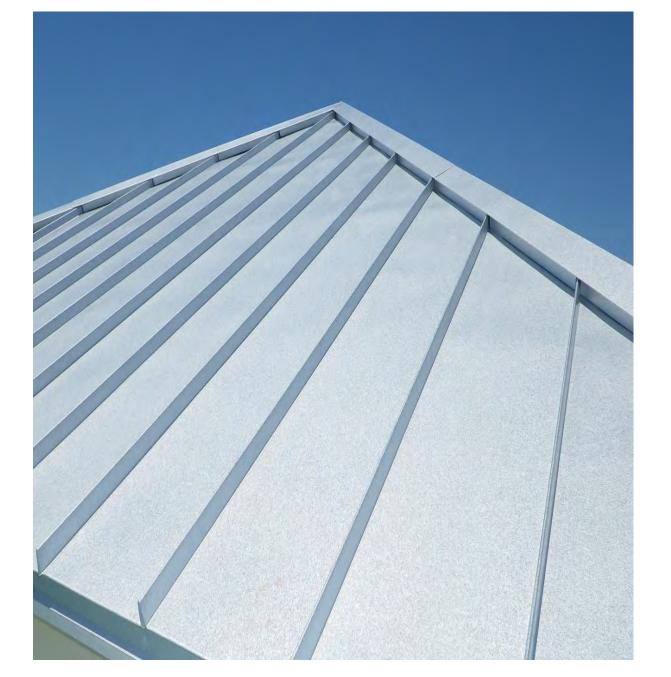



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EXTERIOR MATERIALS